

West Lake Corridor Final Environmental Impact Statement/ Record of Decision and Section 4(f) Evaluation

Appendix E


Appendix E. Engineering Drawings (Part 9 of 10)




West Lake Corridor Final Environmental Impact Statement/ Record of Decision and Section 4(f) Evaluation

Appendix E

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DYER TO HAMMOND, INDIANA

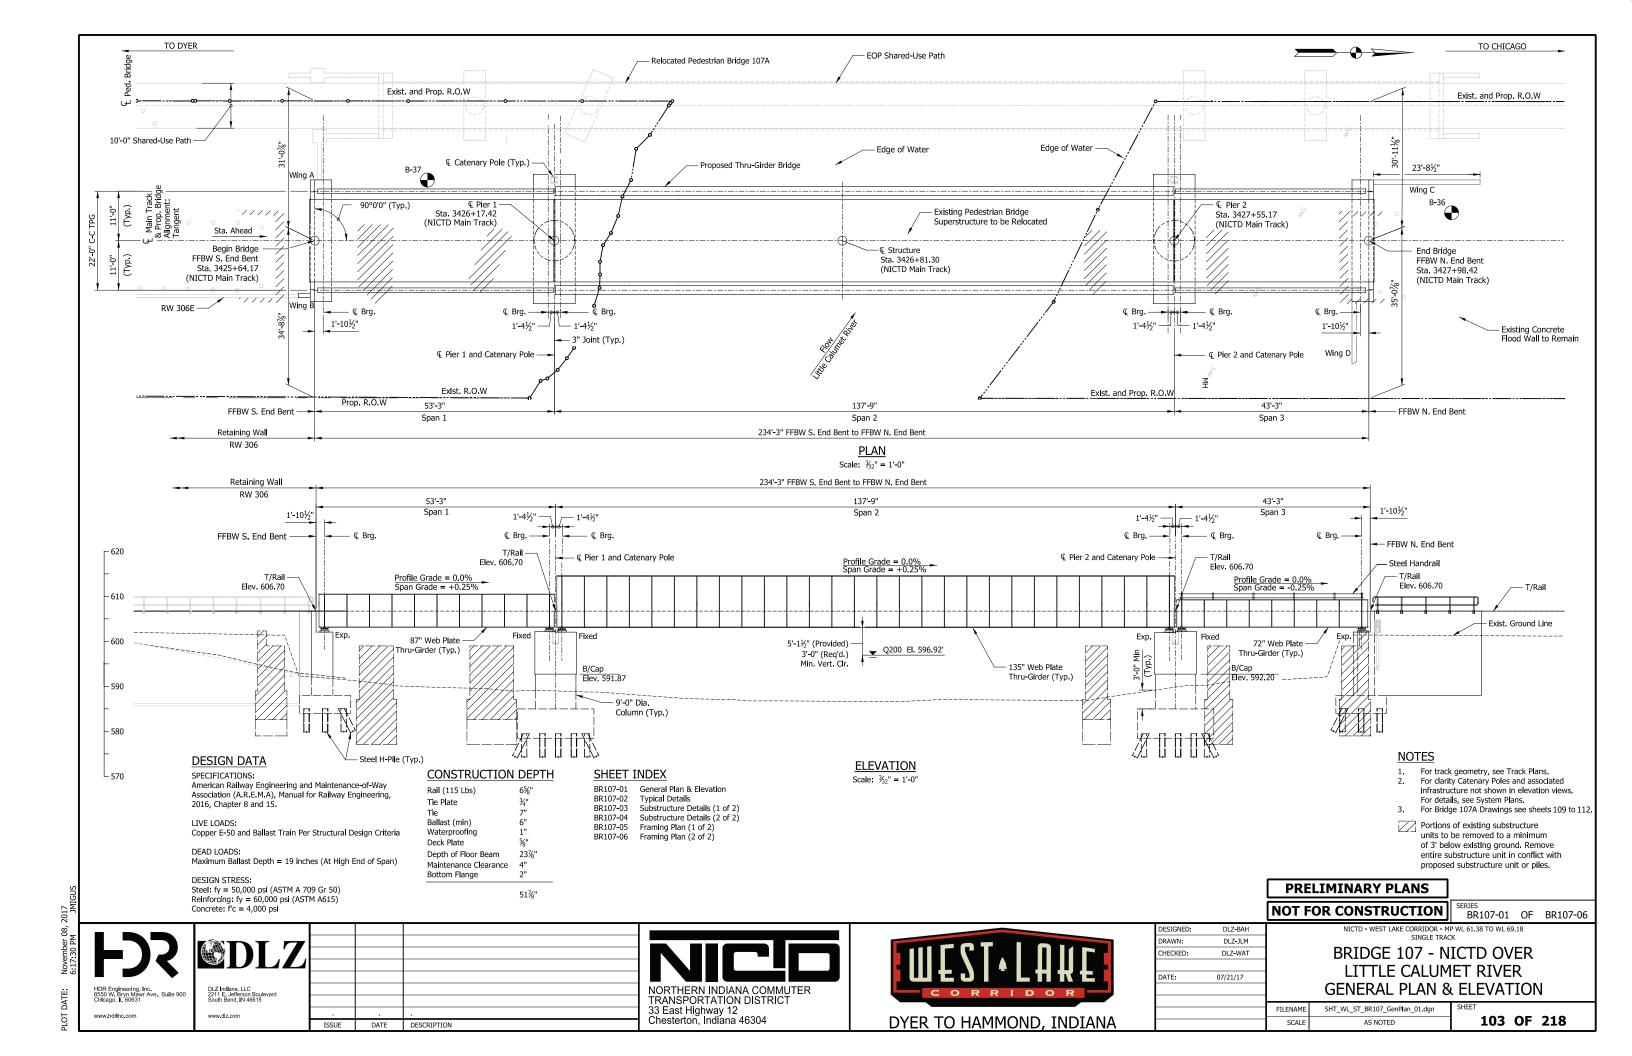
104 OF 218

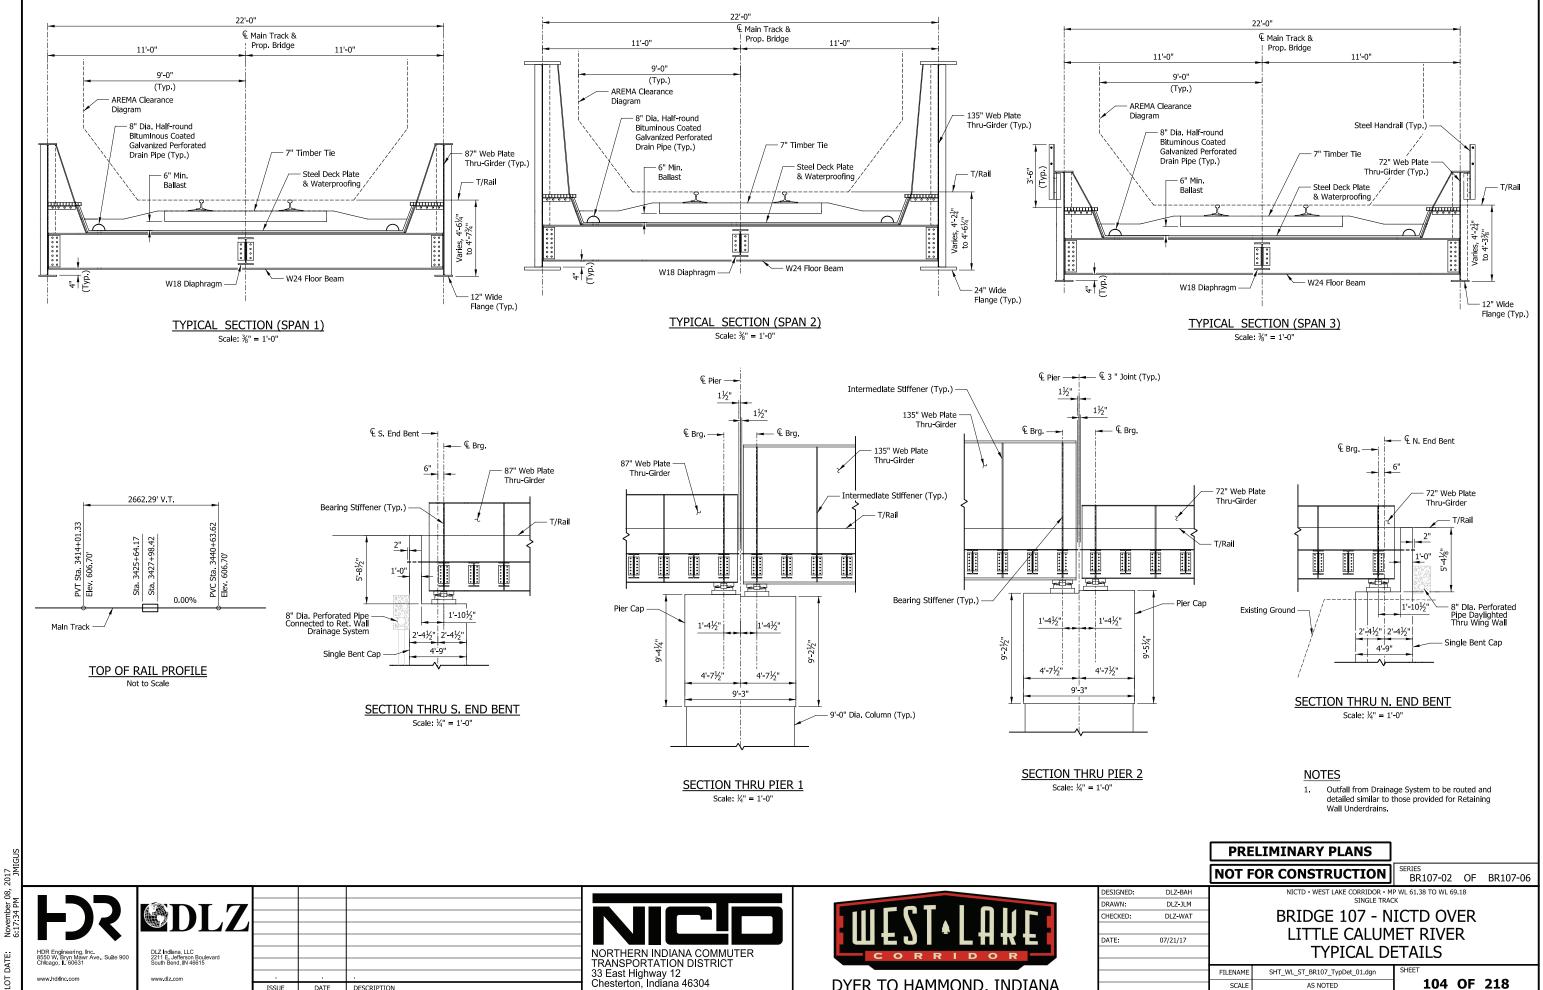
AS NOTED


www.hdrinc.com

www.dlz.com


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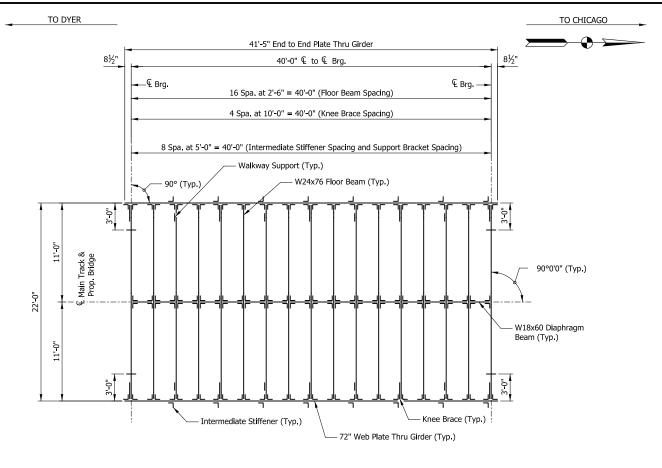


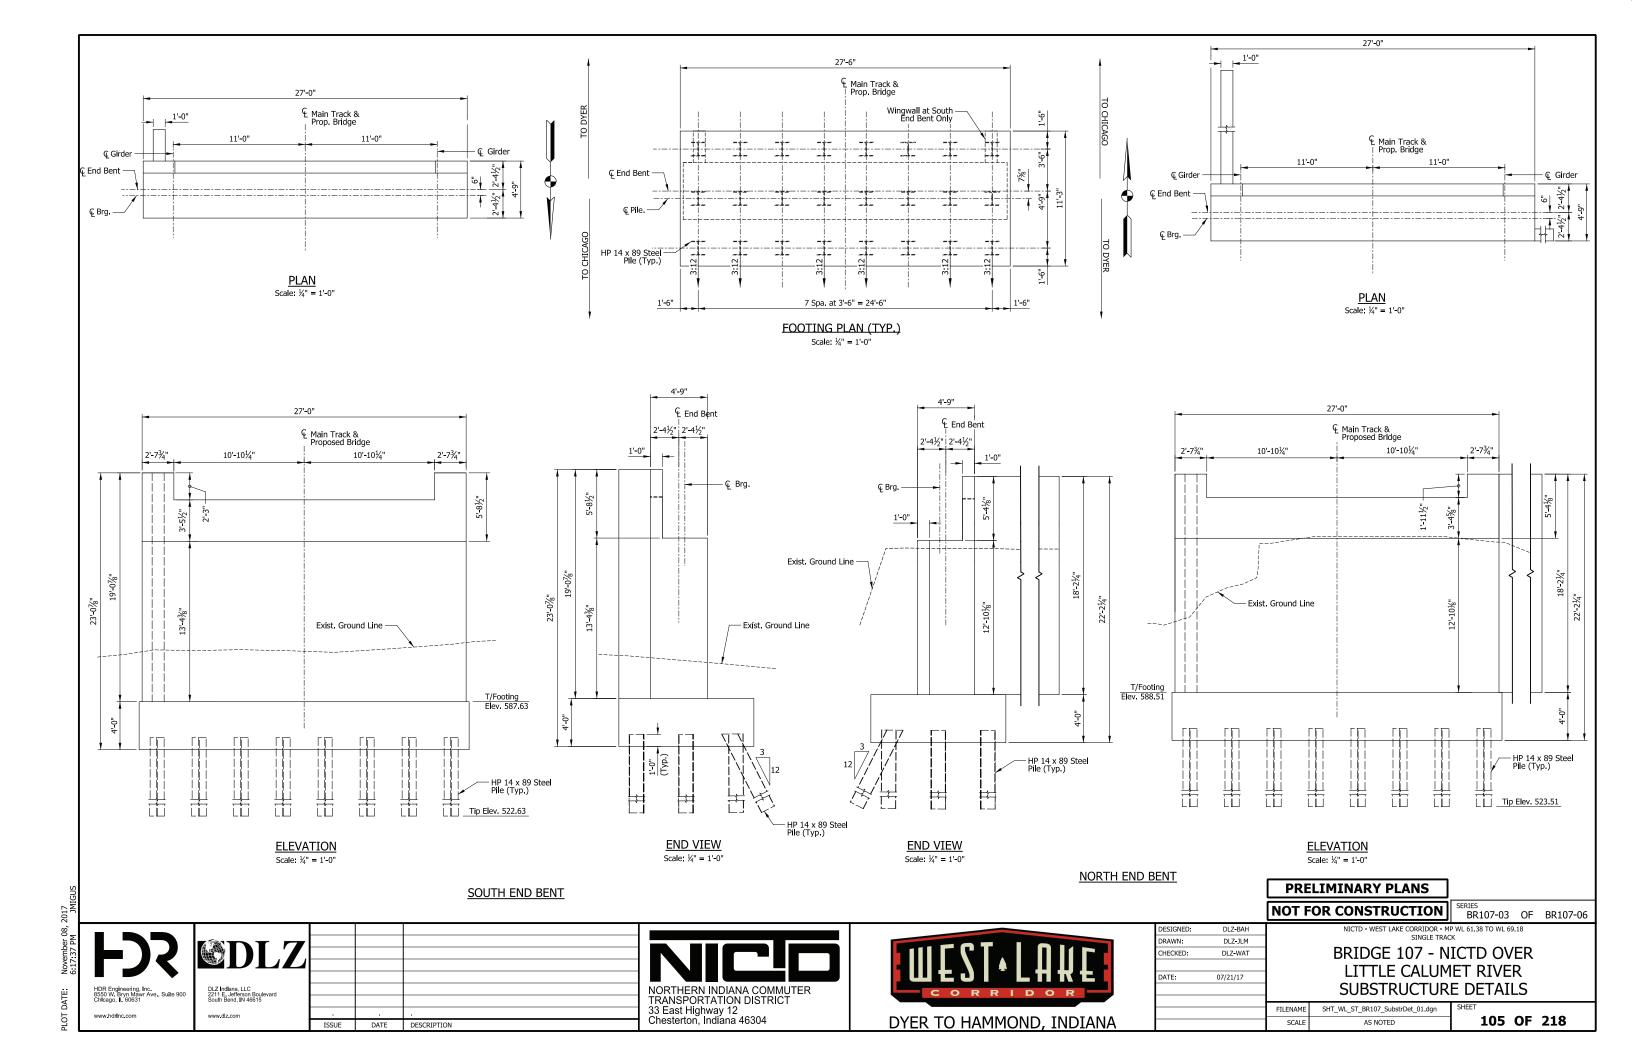

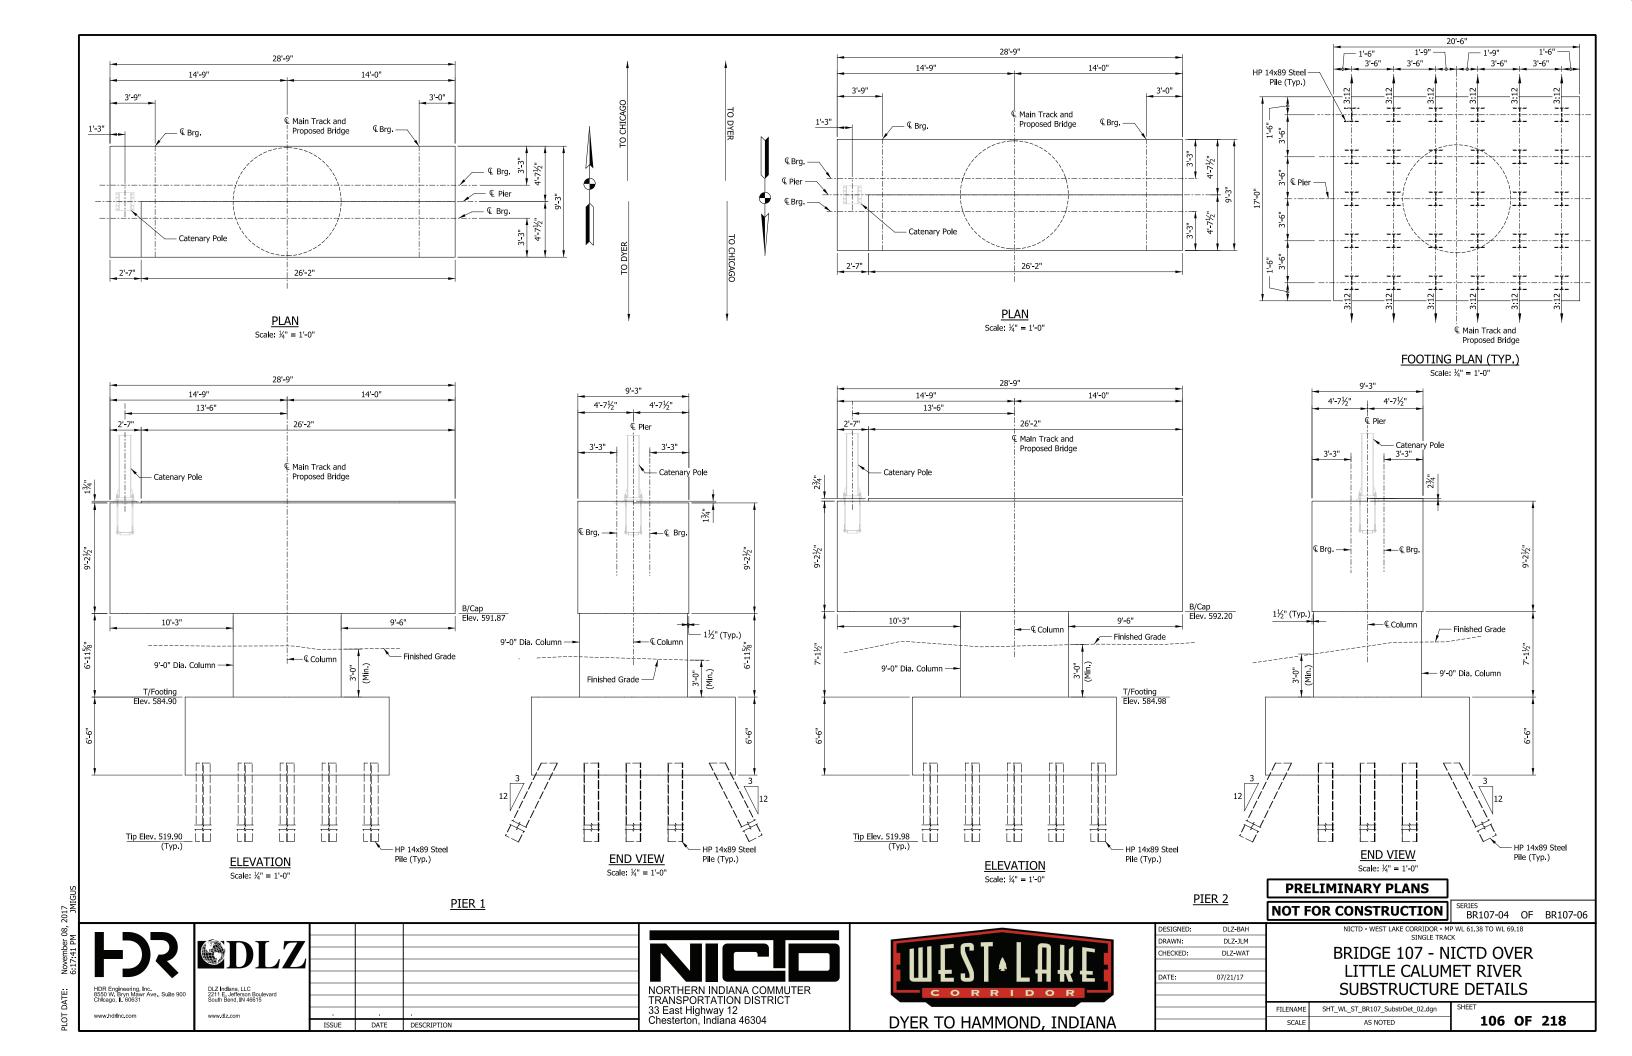


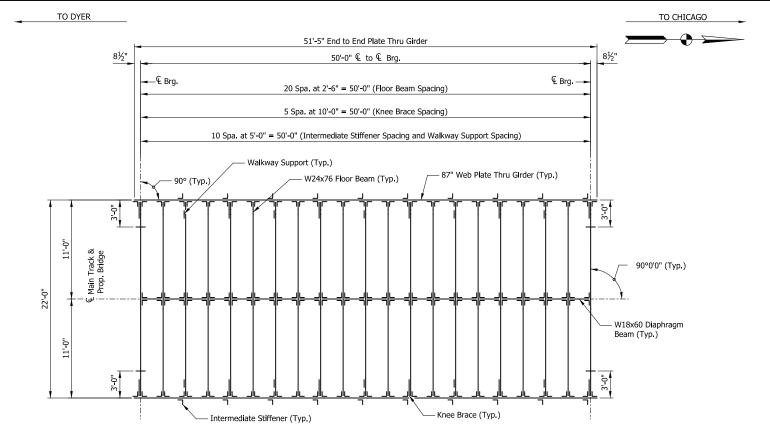FRAMING PLAN (SPAN 1) Scale: $\frac{3}{16}$ " = 1'-0"



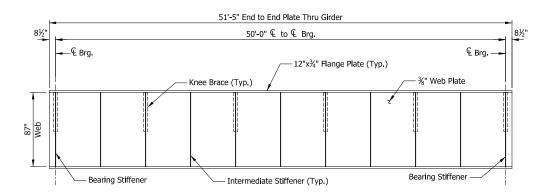

FRAMING PLAN (SPAN 3)

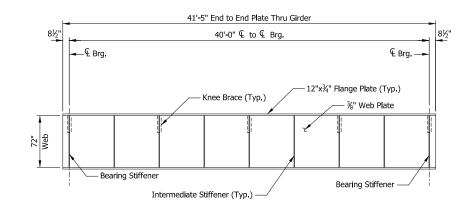

THRU GIRDER ELEVATION (SPAN 3) Scale: $\frac{3}{16}$ " = 1'-0"

DLZ-BAH

DLZ-JLM

DLZ-WAT

07/21/17

DRAWN:

DATE:

HECKED:

PRELIMINARY PLANS

NOT FOR CONSTRUCTION BR107-05 OF BR107-06

NICTD - WEST LAKE CORRIDOR - MP WL 61.38 TO WL 69.18 SINGLE TRACK


BRIDGE 107 - NICTD OVER LITTLE CALUMET RIVER FRAMING PLAN

FILENAME SHT_WL_ST_BR107_FramPlan_01.dgn AS NOTED

107 OF 218


THRU GIRDER ELEVATION (SPAN 1) Scale: ¾₆" = 1'-0"



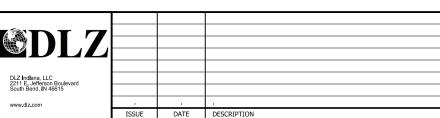





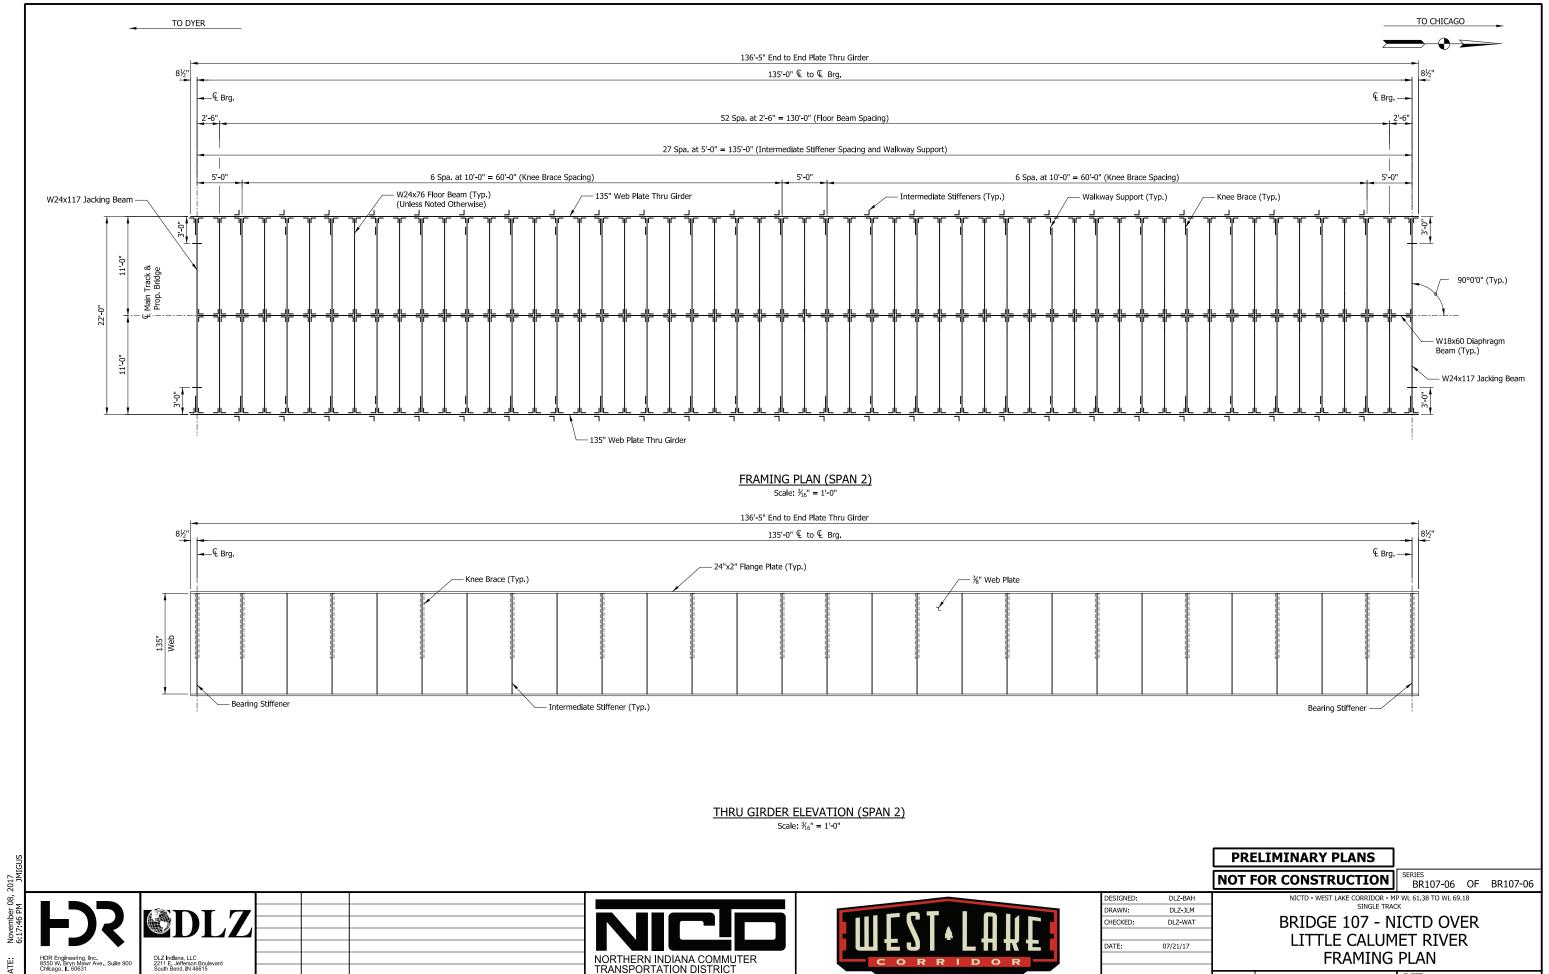

DYER TO HAMMOND, INDIANA

FILENAME

SHT_WL_ST_BR107_FramPlan_02.dgn

AS NOTED


108 OF 218


33 East Highway 12 Chesterton, Indiana 46304

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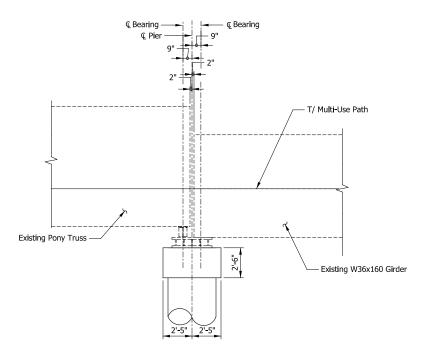
www.dlz.com

DATE DESCRIPTION



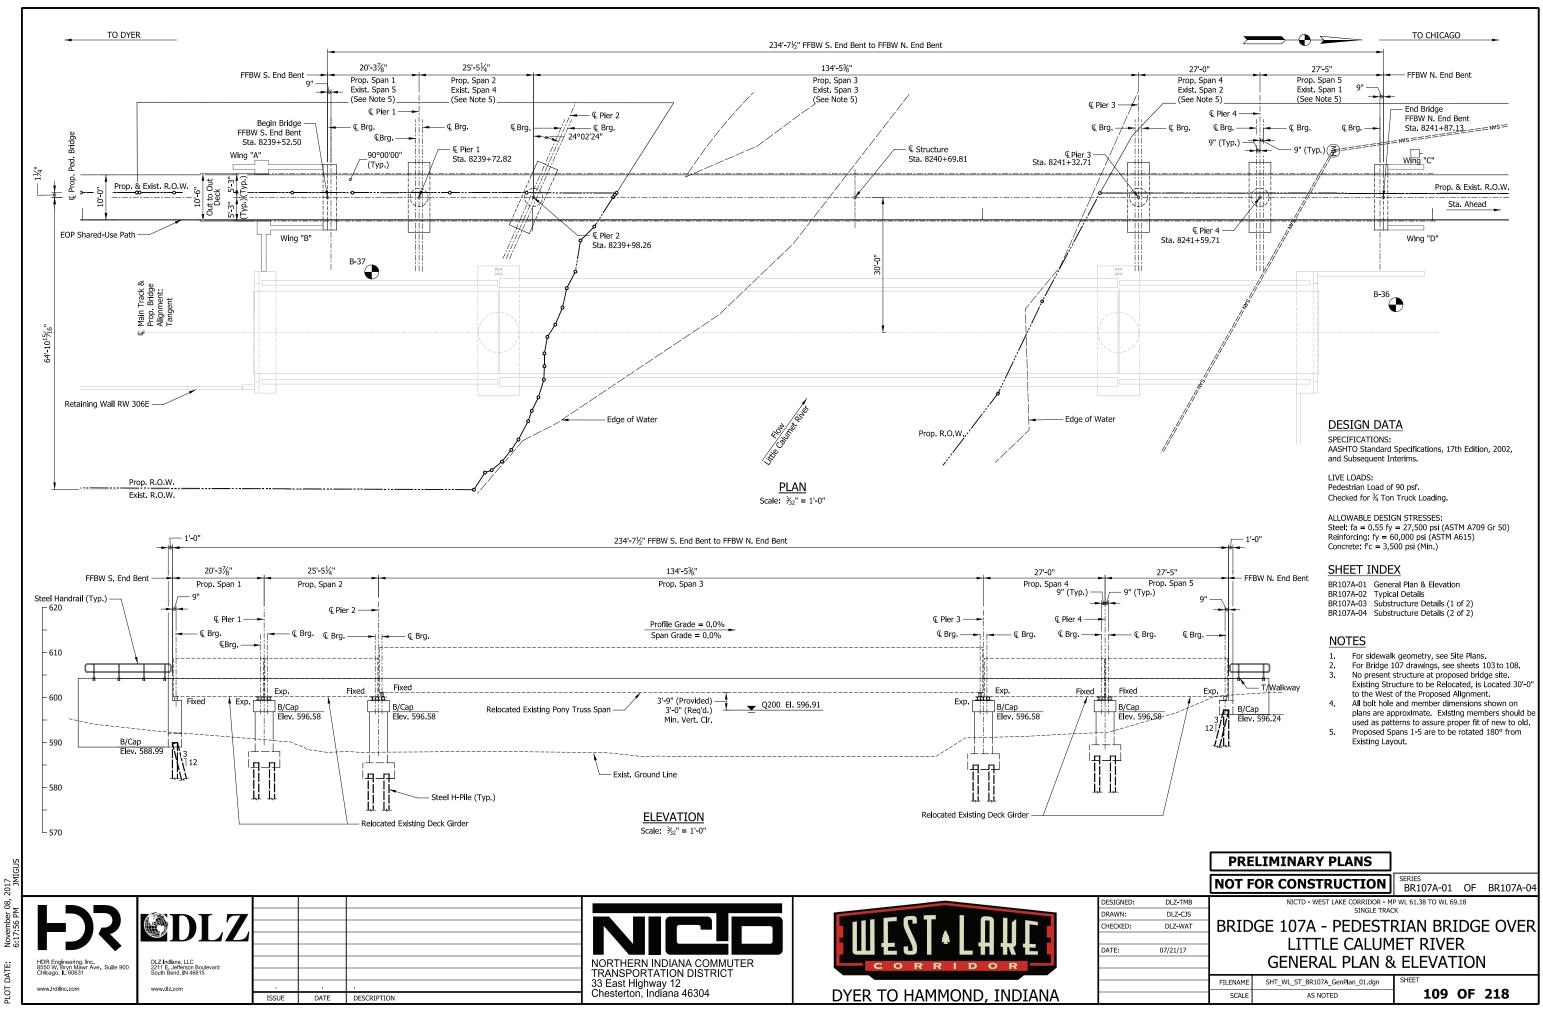


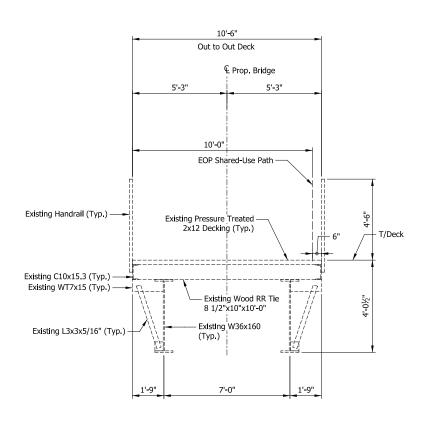TYPICAL SECTION (SPANS 1, 2, 3 & 5)




SECTION THROUGH PIER 3


DATE DESCRIPTION

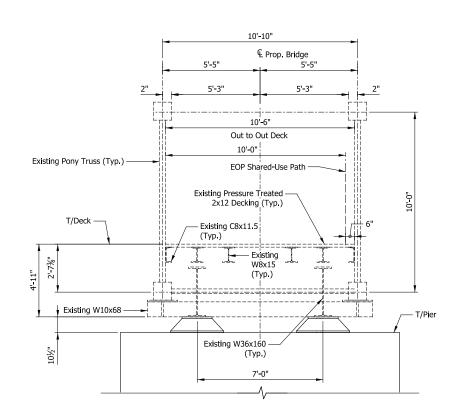


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SECTION THROUGH PIER 4

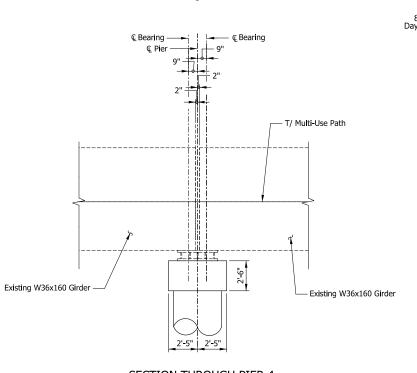

TOP OF SHARED-USE PATH PROFILE

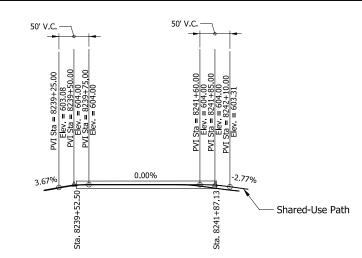

PRELIMINARY PLANS

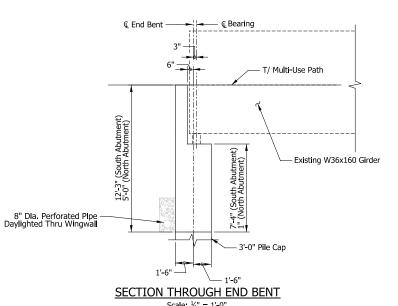DESIGNED:

DRAWN:

DATE:

HECKED:

DLZ-TMB

DLZ-CJS

DLZ-WAT

07/21/17

NOT FOR CONSTRUCTION SERIES BR107A-02 OF BR107A-04

NICTD - WEST LAKE CORRIDOR - MP WL 61.38 TO WL 69.18 SINGLE TRACK

BRIDGE 107A - PEDESTRIAN BRIDGE OVER LITTLE CALUMET RIVER TYPICAL DETAILS

> SHT_WL_ST_BR107A_TypDet_01.dgn 110 OF 218 AS NOTED


NORTHERN INDIANA COMMUTER TRANSPORTATION DISTRICT 33 East Highway 12 Chesterton, Indiana 46304


DYER TO HAMMOND, INDIANA


www.hdrinc.com


DLZ Indlana, LLC 2211 E. Jefferson Boulevard South Bend, IN 46615


www.dlz.com

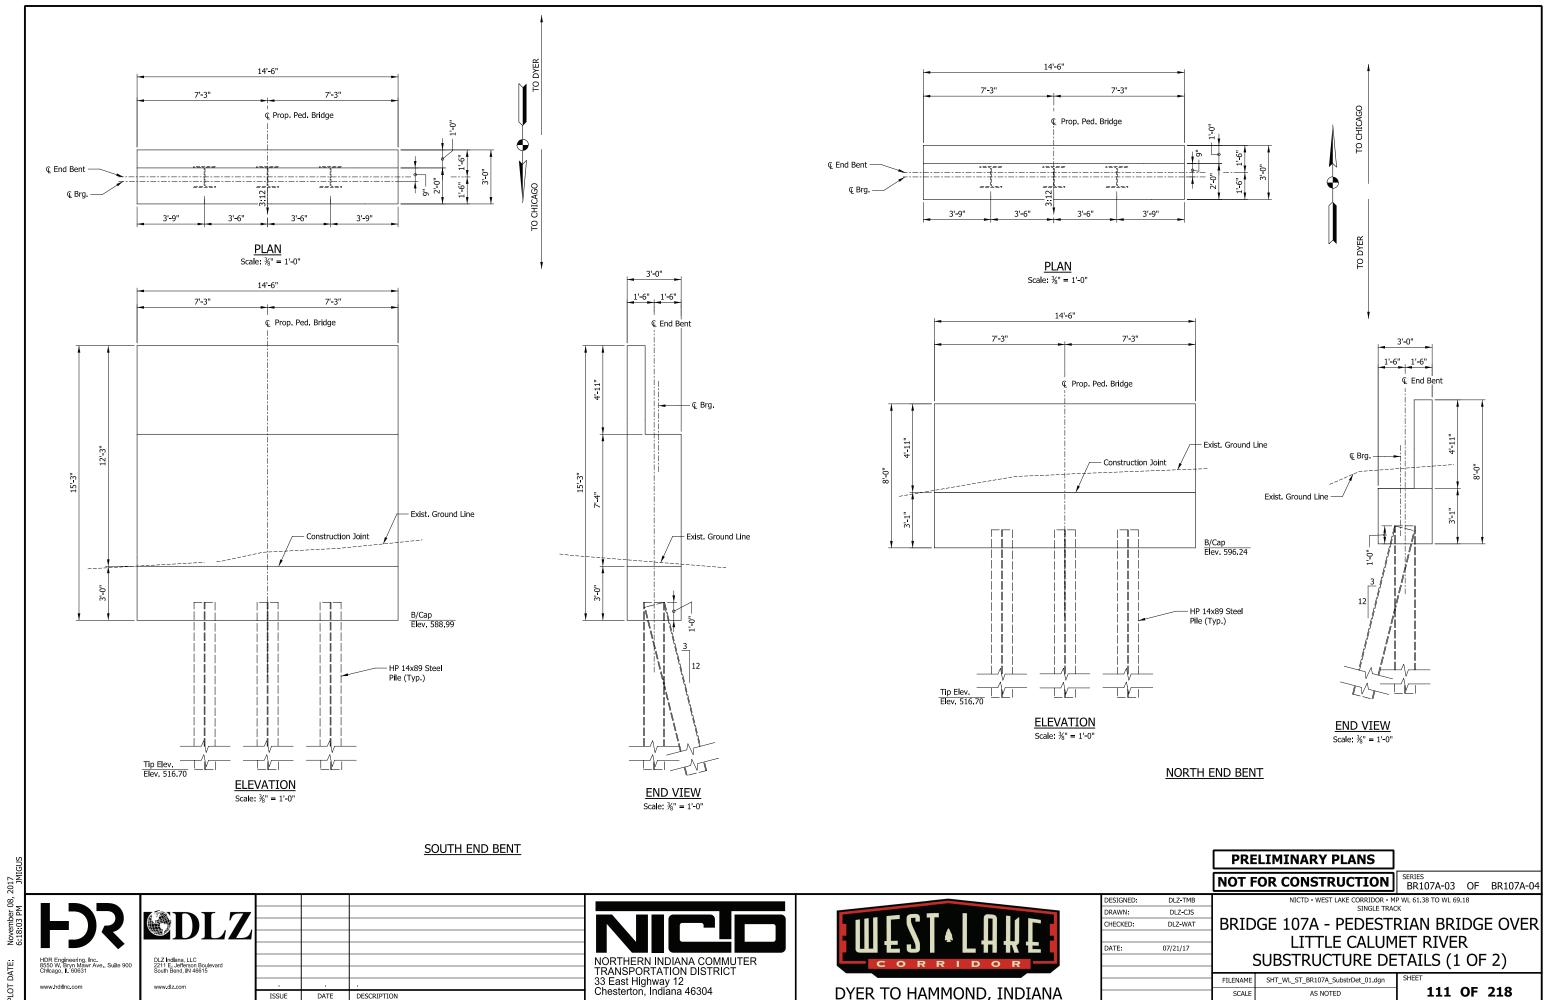


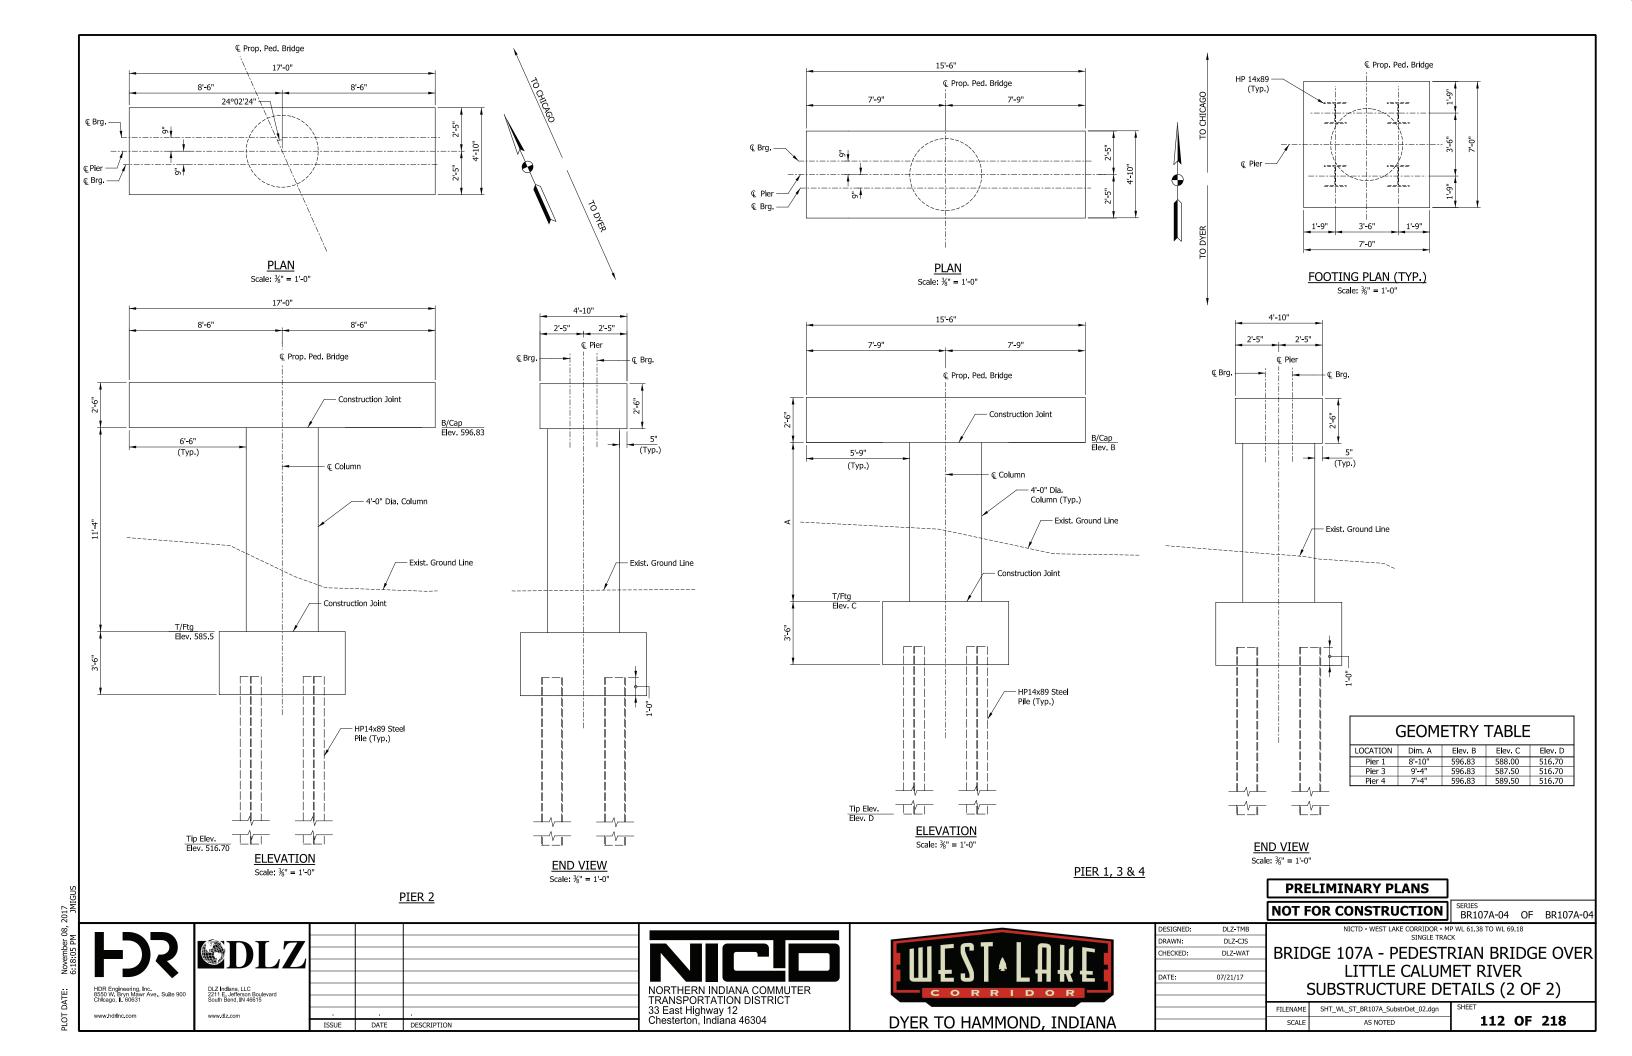


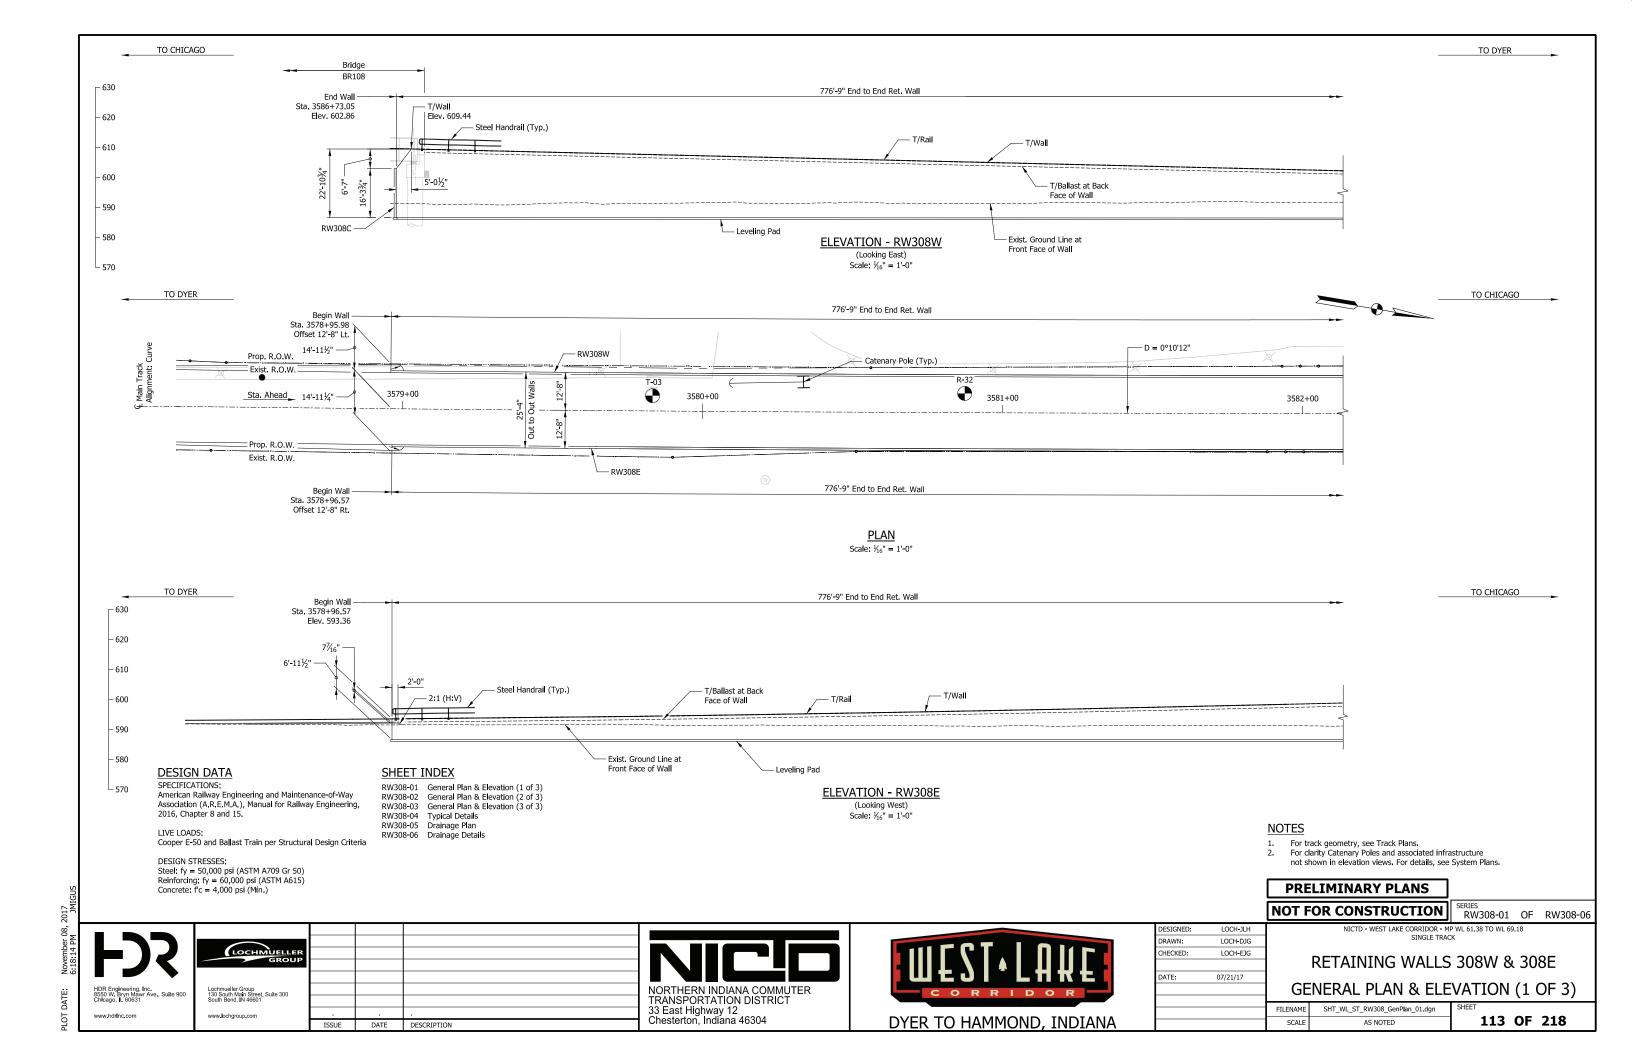

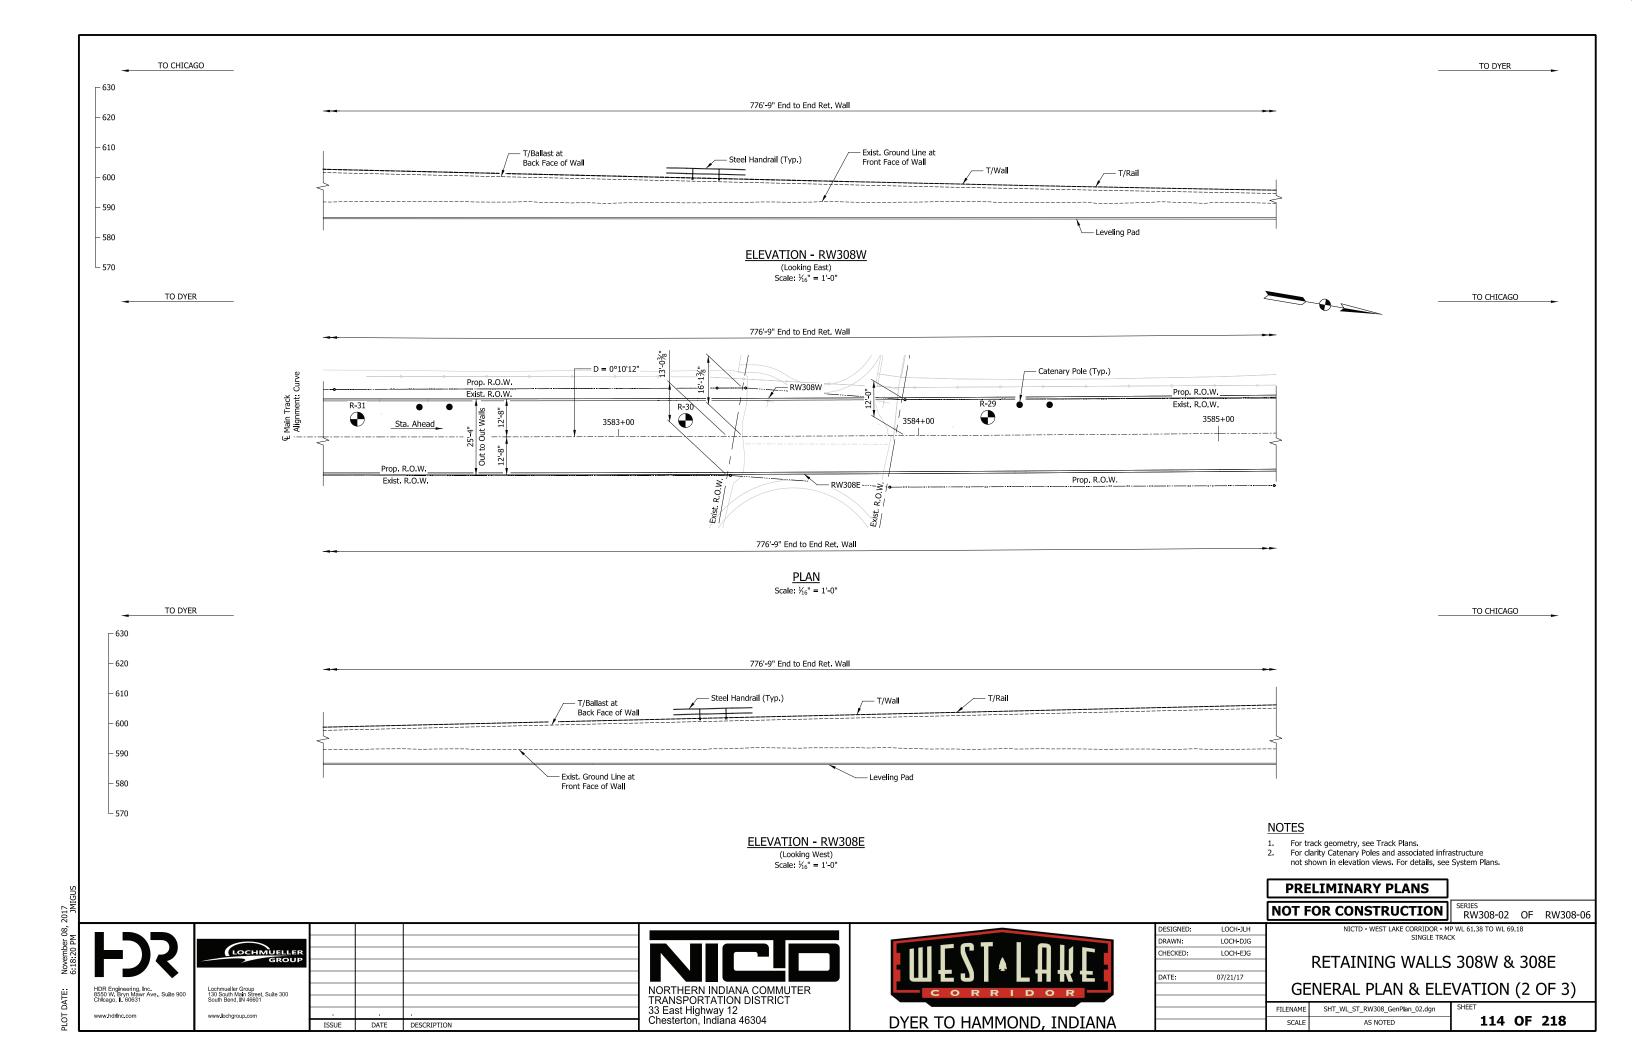

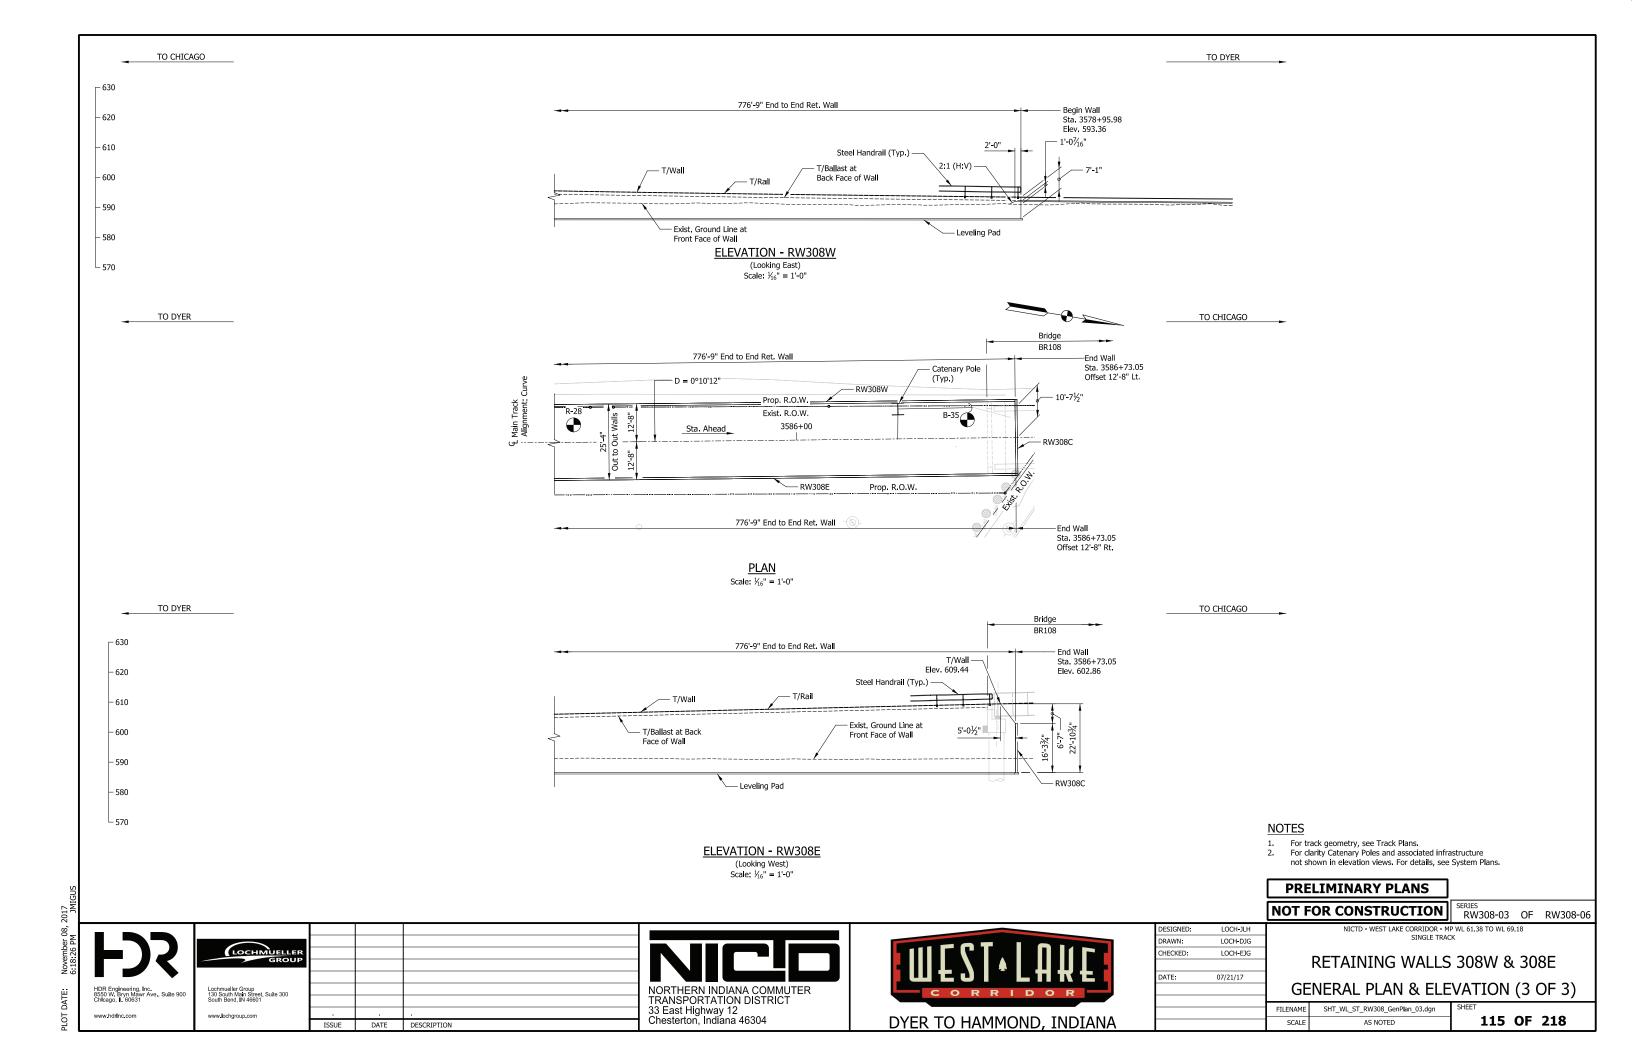


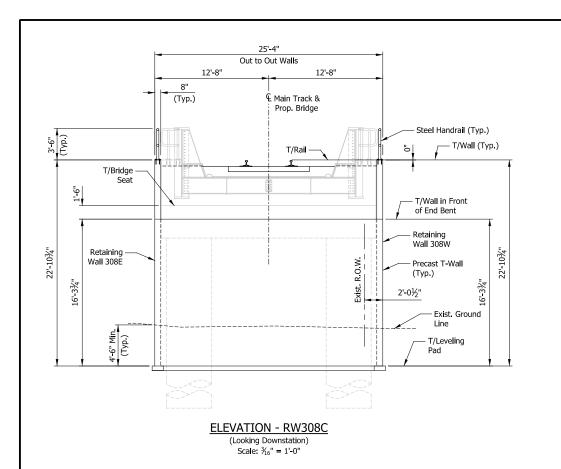


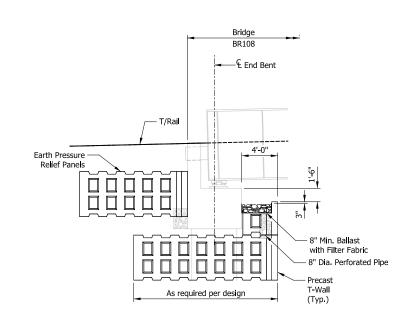


SECTION THRU END BENT (BR108)

Scale: $\frac{3}{16}$ " = 1'-0"

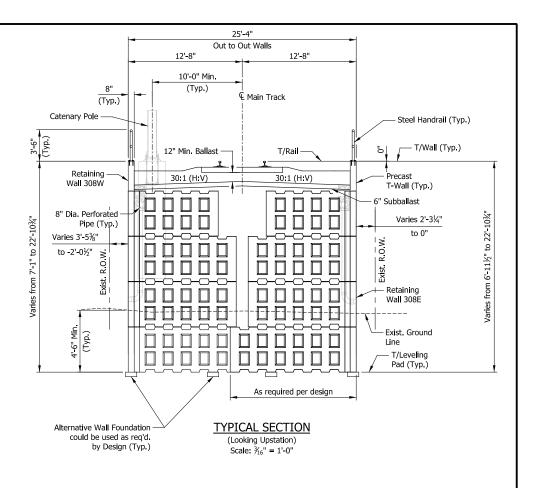

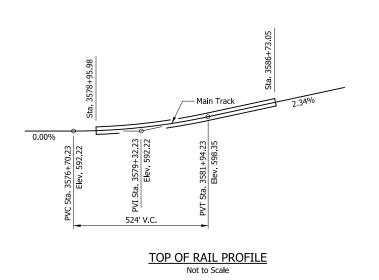

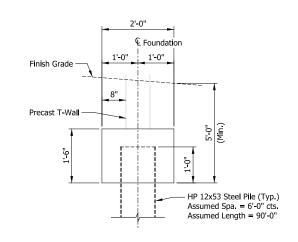

ALTERNATIVE WALL FOUNDATION

Scale: ¾" = 1'-0"

PRELIMINARY PLANS

NOT FOR CONSTRUCTION

SERIES RW308-04 OF RW308-06

HDR Engineering, Inc. 8550 W. Bryn Mawr Ave., Suite 900 Chleago, L. 60631

Lochmueller Group
130 South Main Street, Suite 300
South Bend, IN 46001

www.lochgroup.com

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DRAWN:	LOCH-DJG	
CHECKED:	LOCH-EJG	
DATE:	07/21/17	


RETAINING WALLS 308W & 308E


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SCALE AS NOTED SHEET


AS NOTED SHEET

116 OF 218




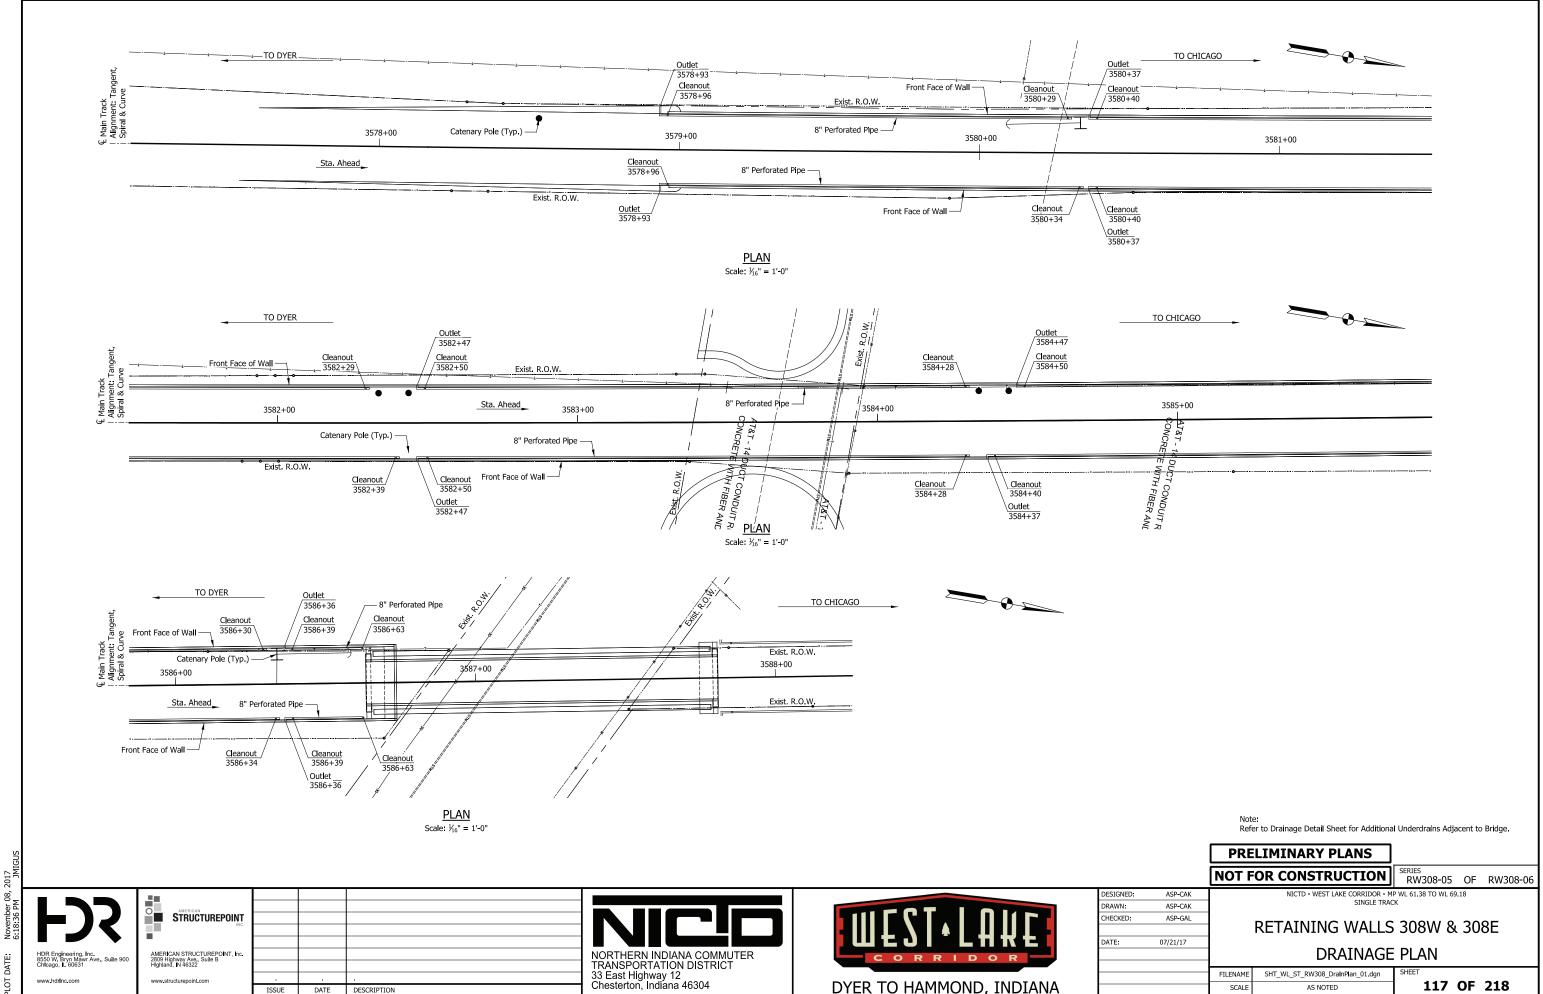

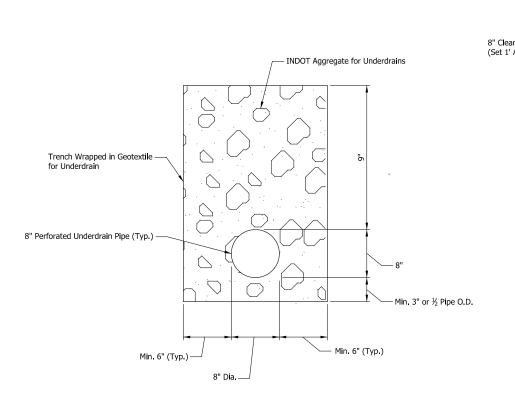TYPICAL UNDERDRAIN SECTION

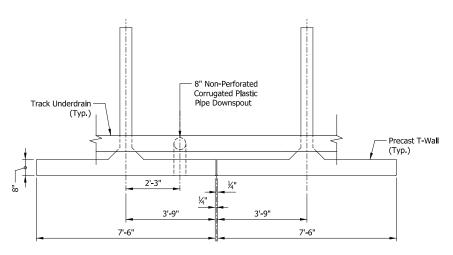


TYPICAL WALL PENETRATION DETAIL

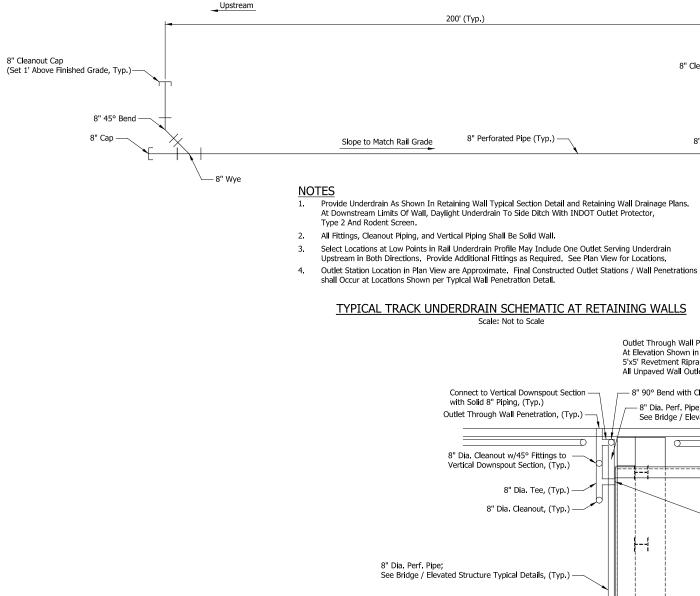

Outlet Invert Outlet Staton Right Left 3578+93 590.1 591.4 3580+37 590.5 593.5 3582+47 591.1 593.3 3584+37 593.3 3584+47 593.6 3586+36 593.0 592.8

UNDERDRAIN OUTLET ELEVATION SUMMARY TABLE

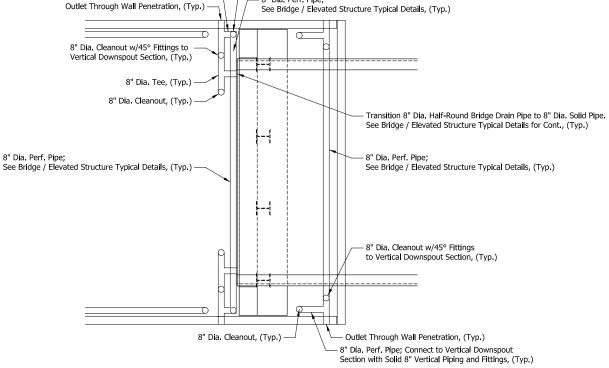

TYPICAL UNDERDRAIN PLAN DETAIL AT RETAINING WALL INTERFACE WITH BRIDGE OR ELEVATED STRUCTURE

> PRELIMINARY PLANS NOT FOR CONSTRUCTION

Downstream _

8" 45° Bend -

8" 90° Bend -

8" Cleanout Cap

8" 45° Bend

Outlet Through Wall Penetration With Rodent Grate At Elevation Shown in Summary Table. Provide 5'x5' Revetment Riprap On Geotextiles At

All Unpaved Wall Outlet Locations

- 8" 90° Bend with Cleanout, (Typ.)

8" Cleanout Cap

8" 45° Bend

See Note

RW308-06 OF RW308-06

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200' (Typ.)

8" Perforated Pipe (Typ.) —

Scale: Not to Scale

Connect to Vertical Downspout Section

with Solid 8" Piping, (Typ.)


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DATE: 07/21/17	CHECKED:	ASP-GAL	
DATE: 07/21/17			
	DATE:	07/21/17	

NICTD - WEST LAKE CORRIDOR - MP WL 61.38 TO WL 69.18 SINGLE TRACK


RETAINING WALLS 308W & 308E

DRAINAGE DETAILS

SHT_WL_ST_RW308_DraInDet_01.dgn 118 OF 218 AS NOTED

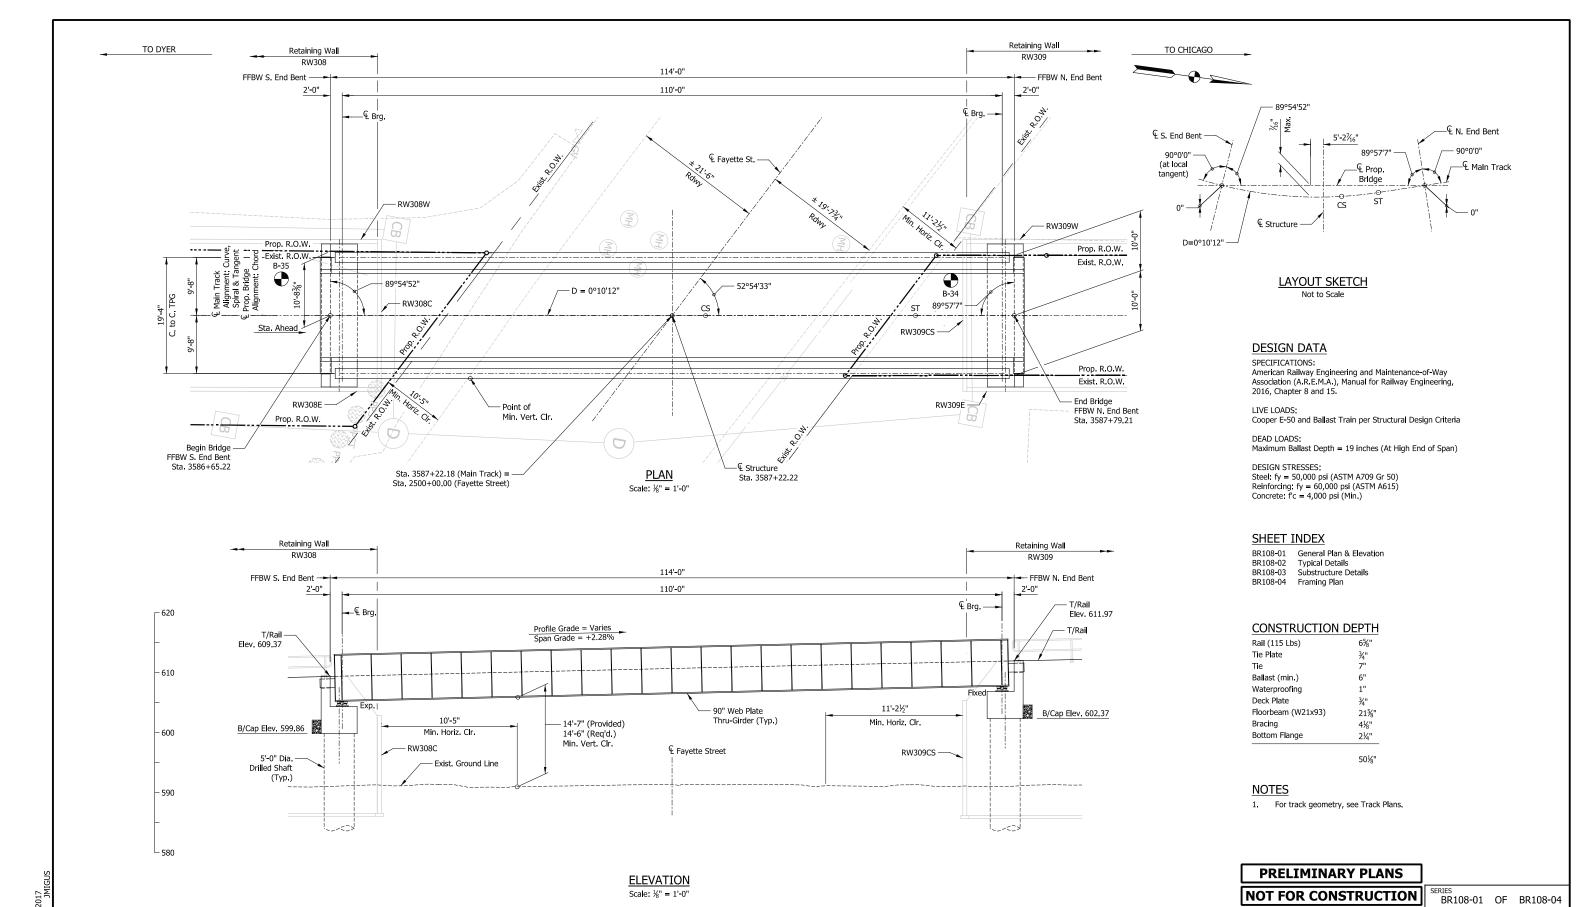

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Scale: 1/8" = 1'-0"

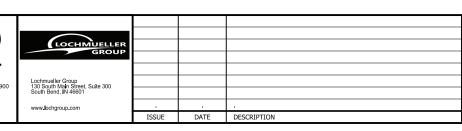


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NICTD - WEST LAKE CORRIDOR -	М	P WL 61.38 TO WL 69.18
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BRIDGE 108 - I	V	ICTD OVER


FAYETTE STREET GENERAL PLAN & ELEVATION

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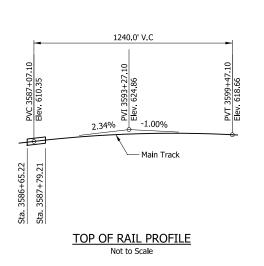
FILENAME 119 OF 218 SCALE AS NOTED





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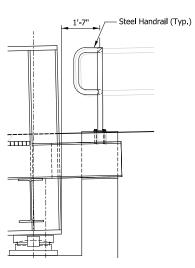


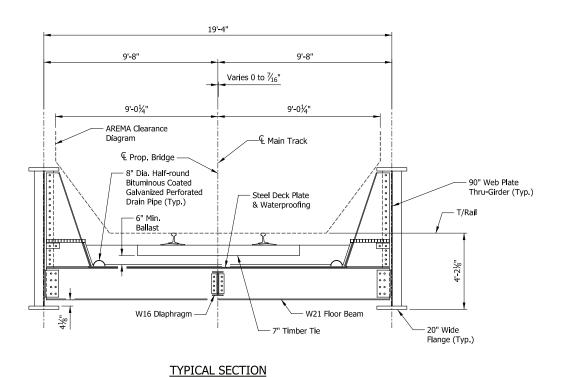SECTION THRU END BENT * at Right Angle Scale: ½" = 1'-0"

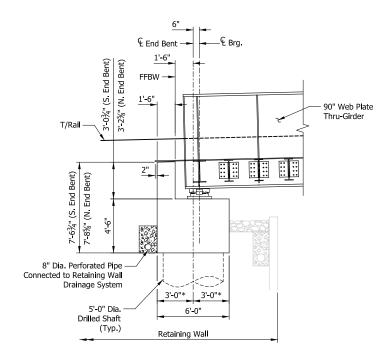



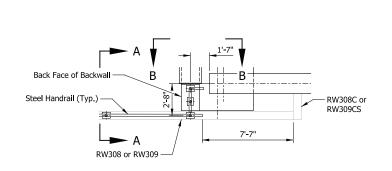

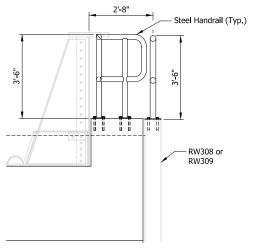

NOTES

Outfall from Drainage System to be routed and detailed similar to those provided for Retaining Wall Underdrains.

HANDRAIL LAYOUT AT BRIDGE CORNERS Scale: 1/4" = 1'-0"

VIEW A-A Scale:½" = 1'-0"

VIEW B-B Scale:½" = 1'-0"

LOCH-EJG

LOCH-DJG

DESIGNED:

DRAWN:

DATE:

HECKED:

PRELIMINARY PLANS NOT FOR CONSTRUCTION

SERIES BR108-02 OF BR108-04

NICTD - WEST LAKE CORRIDOR - MP WL 61.38 TO WL 69.18 SINGLE TRACK

BRIDGE 108 - NICTO OVER

DKIDGE ING - NICID OVE		
	FAYETTE S	TREET
	TYPICAL D	ETAILS
SHT WL ST BR108 TypDet 01 dan		SHEET

Lochmueller Group 130 South Main Street, Suite 300 South Bend, IN 46601 www.lochgroup.com DATE DESCRIPTION






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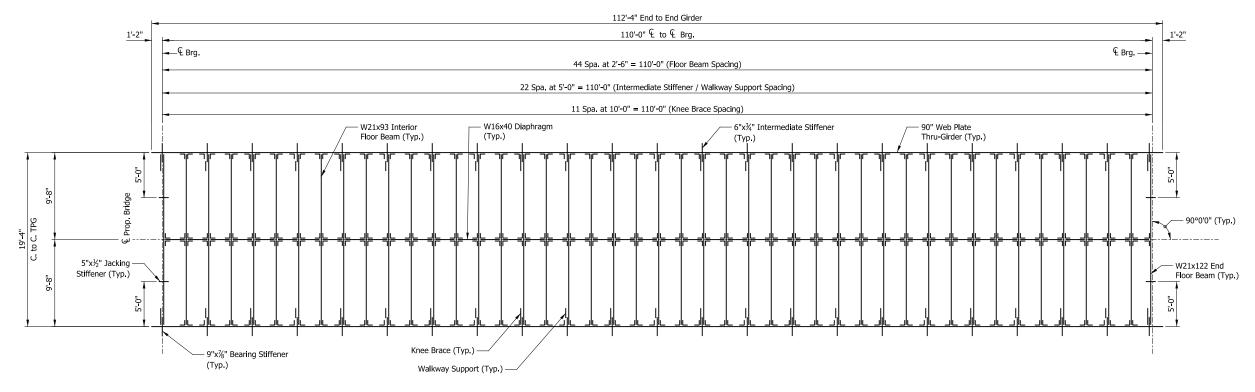
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FILENAME 120 OF 218 AS NOTED




TO DYER

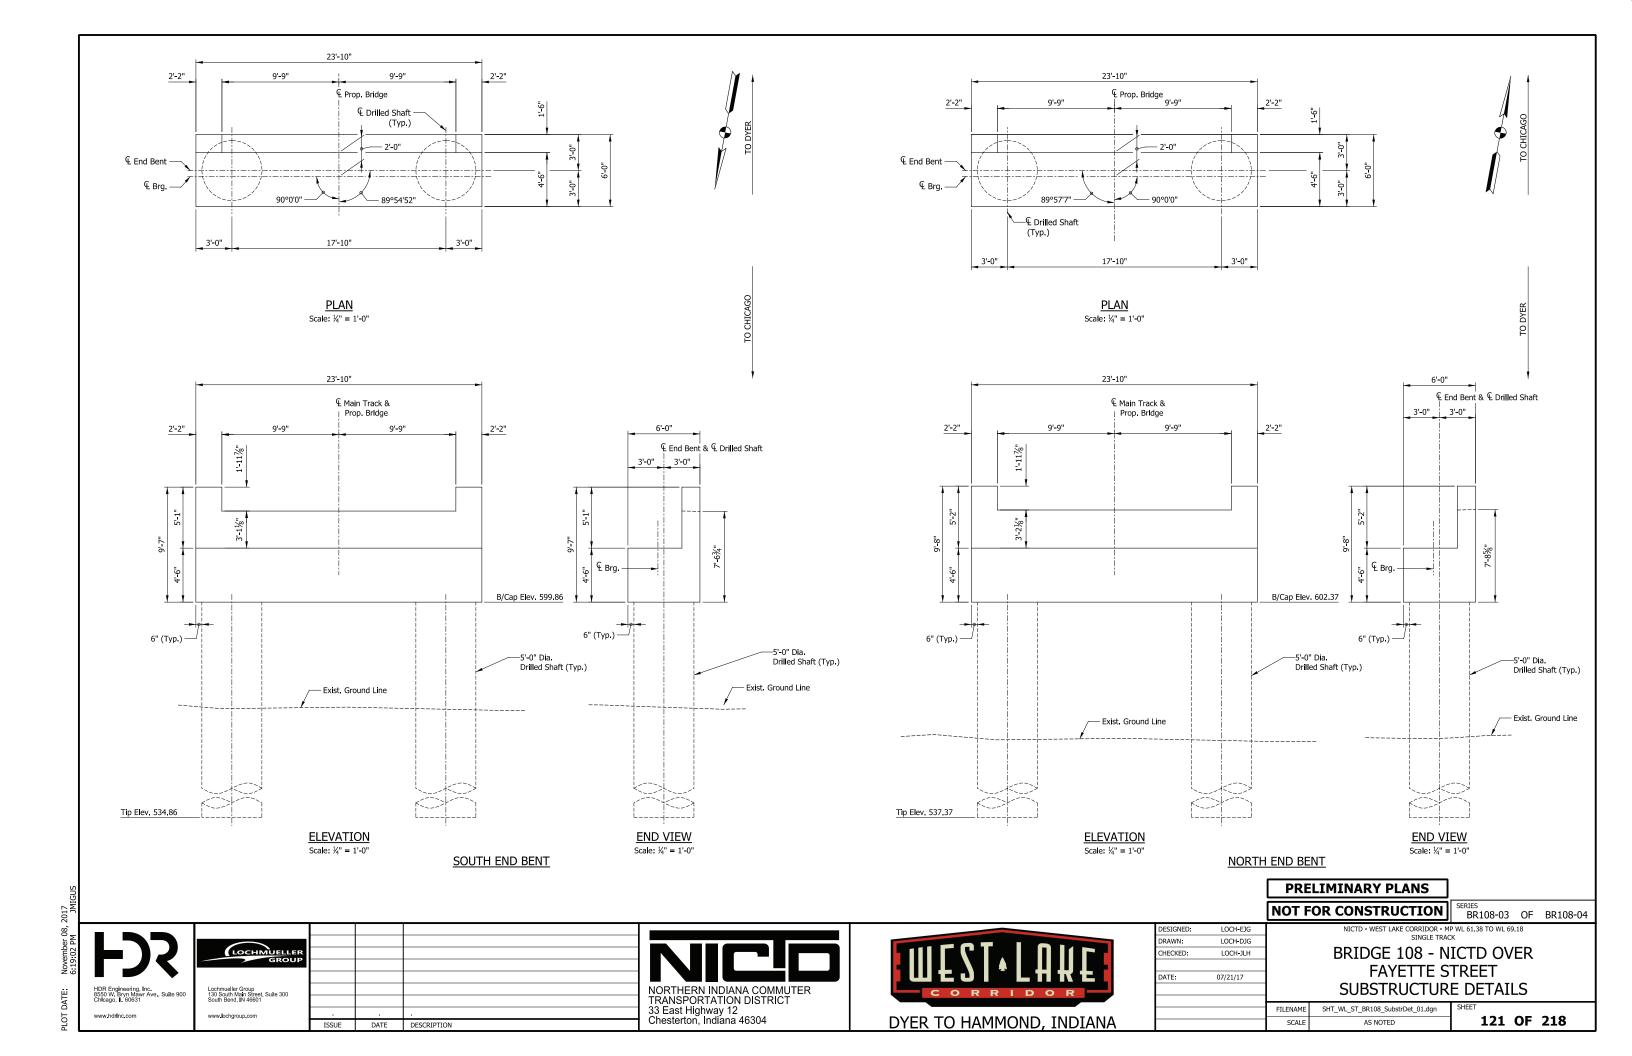



FRAMING PLAN Scale: 3/16" = 1'-0"

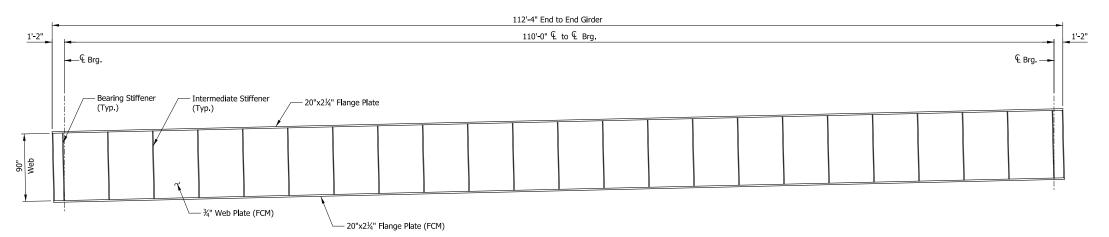

GIRDER EXTERIOR ELEVATION Scale: $\frac{3}{16}$ " = 1'-0"

PRELIMINARY PLANS

NOT FOR CONSTRUCTION SERIES BR108-04 OF BR108-04

LOCH-EJG

LOCH-DJG

LOCH-JLH

FILENAME

07/21/17

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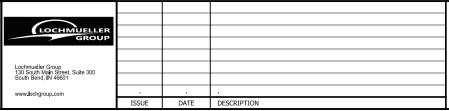
NICTD - WEST LAKE CORRIDOR - MP WL 61.38 TO WL 69.18 SINGLE TRACK

BRIDGE 108 - NICTD OVER

FAYETTE STREET FRAMING PLAN


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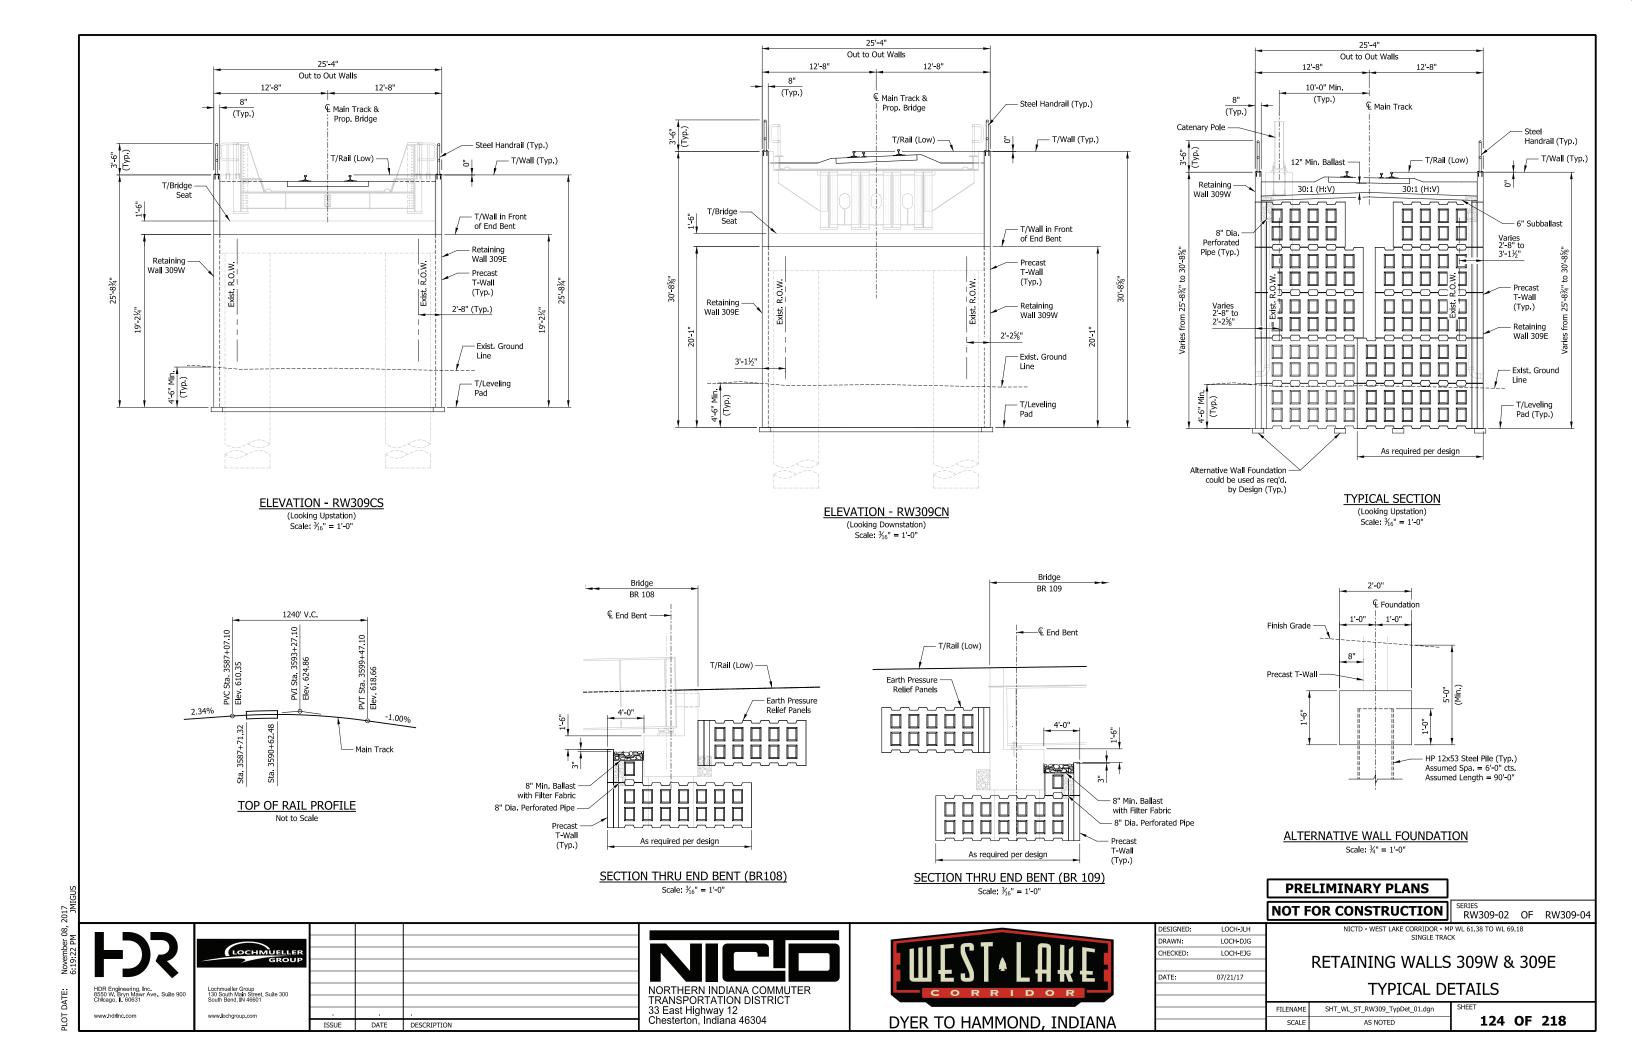
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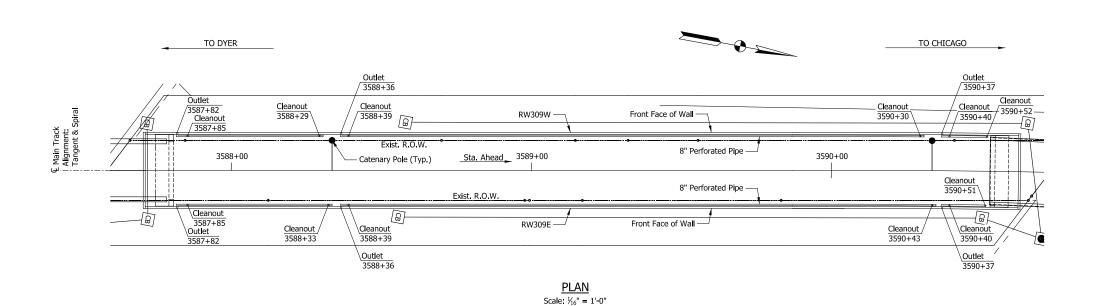










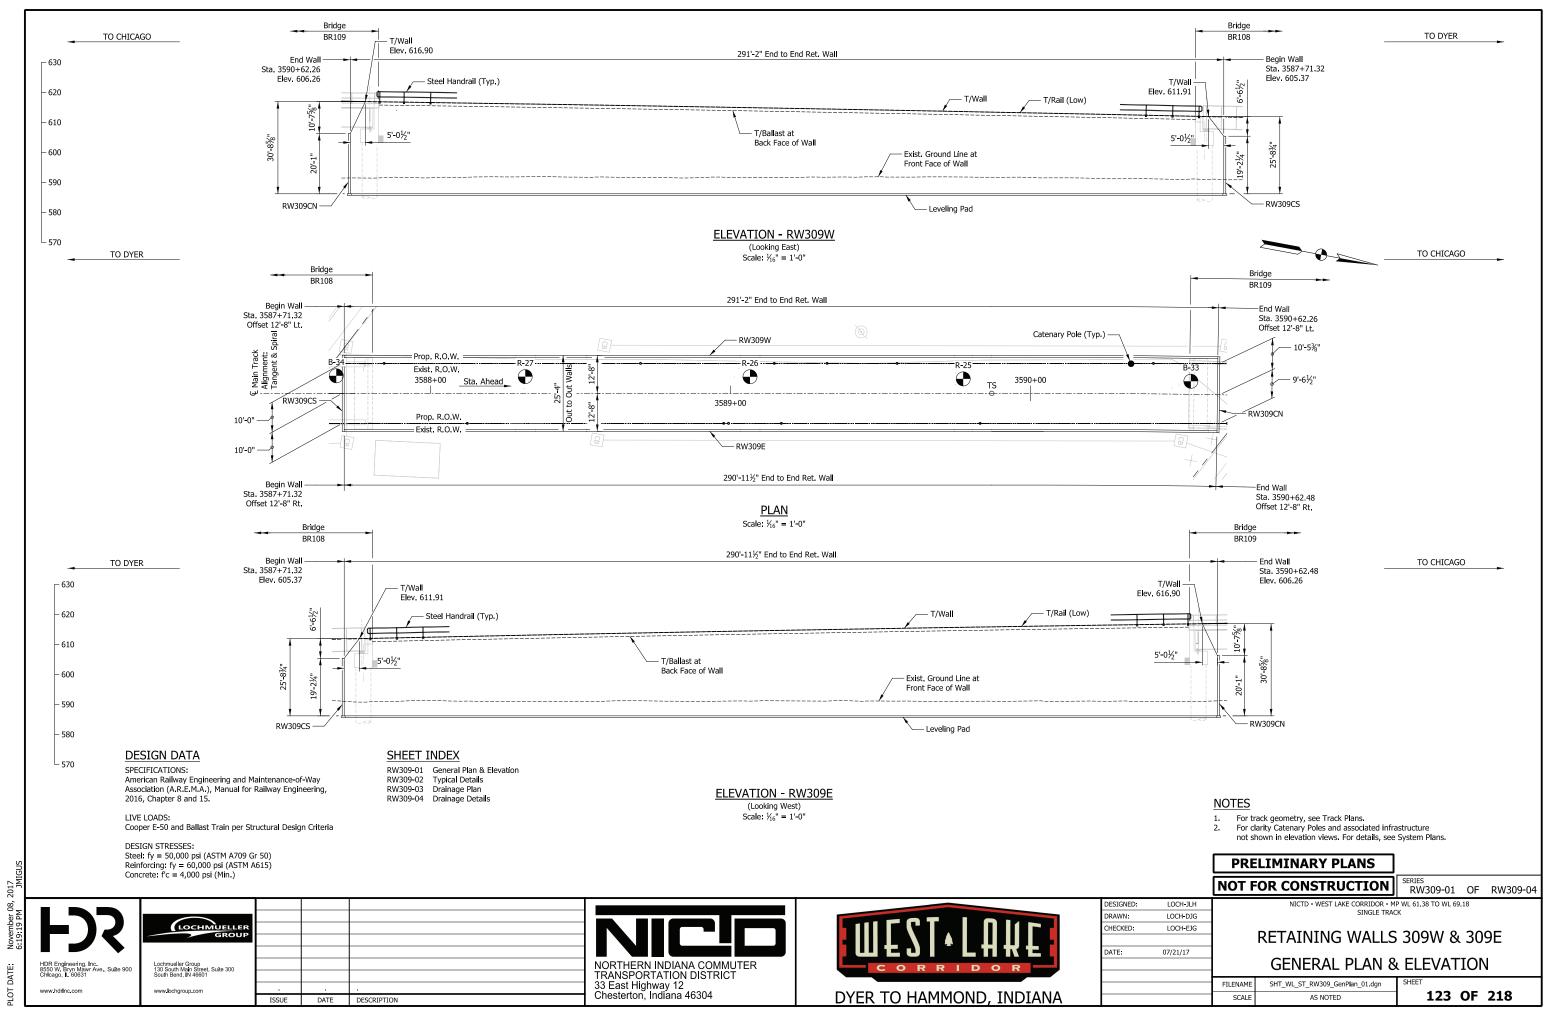

DESIGNED:

ASP-CAK

ASP-GAL

07/21/17

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Note: Refer to Drainage Detail Sheet for Additional Underdrains Adjacent to Bridge.

PRELIMINARY PLANS

NOT FOR CONSTRUCTION | SERIES | RW309-03 | OF RW309-04

NICTD - WEST LAKE CORRIDOR - MP WL 61.38 TO WL 69.18 SINGLE TRACK

RETAINING WALLS 309W & 309E

DRAINAGE PLAN


SHT_WL_ST_RW309_DraInPlan_01.dgn 125 OF 218 AS NOTED

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NORTHERN INDIANA COMMUTER TRANSPORTATION DISTRICT 33 East Highway 12 Chesterton, Indiana 46304





TYPICAL UNDERDRAIN SECTION

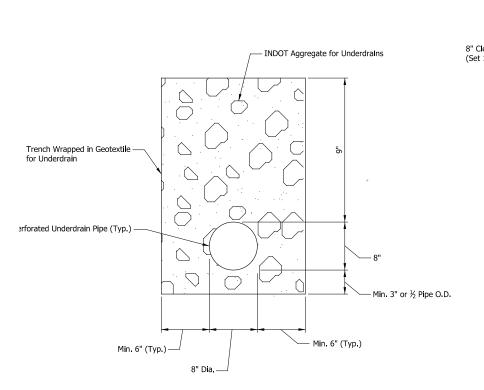Corrugated Plastic Pipe Downspout Track Underdrain (Tvp.) 2'-3"

TYPICAL WALL PENETRATION DETAIL

Upstream 200' (Typ.) 8" Cleanout Cap (Set 1' Above Finished Grade, Typ.)-8" 45° Bend 8" Perforated Pipe (Typ.) — Slope to Match Rail Grade Type 2 And Rodent Screen. 2. All Fittings, Cleanout Piping, and Vertical Piping Shall Be Solid Wall.

Provide Underdrain As Shown In Retaining Wall Typical Section Detail and Retaining Wall Drainage Plans. At Downstream Limits Of Wall, Daylight Underdrain To Side Ditch With INDOT Outlet Protector,

- Select Locations at Low Points in Rail Underdrain Profile May Include One Outlet Serving Underdrain Upstream in Both Directions. Provide Additional Fittings as Required. See Plan View for Locations.
- Outlet Station Location in Plan View are Approximate. Final Constructed Outlet Stations / Wall Penetrations shall Occur at Locations Shown per Typical Wall Penetration Detail.

TYPICAL TRACK UNDERDRAIN SCHEMATIC AT RETAINING WALLS

Scale: Not to Scale

Outlet Through Wall Penetration With Rodent Grate At Elevation Shown in Summary Table. Provide 5'x5' Revetment Riprap On Geotextiles At

8" Cleanout Cap

8" 45° Bend

Downstream _

8" 45° Bend -


8" 90° Bend -

8" Cleanout Cap

8" 45° Bend

See Note

All Unpaved Wall Outlet Locations

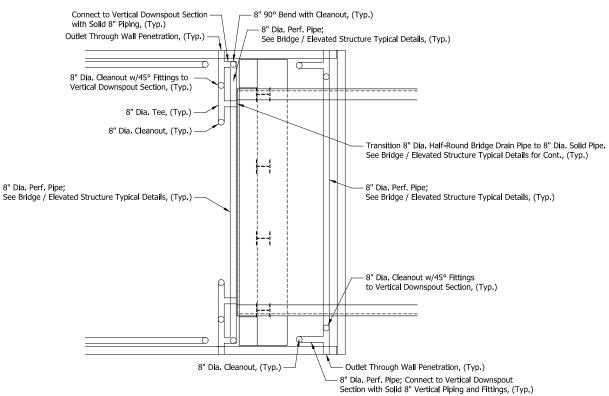

TYPICAL UNDERDRAIN PLAN DETAIL AT RETAINING WALL INTERFACE WITH BRIDGE OR ELEVATED STRUCTURE

> PRELIMINARY PLANS NOT FOR CONSTRUCTION

RW309-04 OF RW309-04

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Outlet Invert
Outlet Station Right Left 3587+82 592.8 592.9

3590+37 593.0 593.5

UNDERDRAIN OUTLET ELEVATION SUMMARY TABLE




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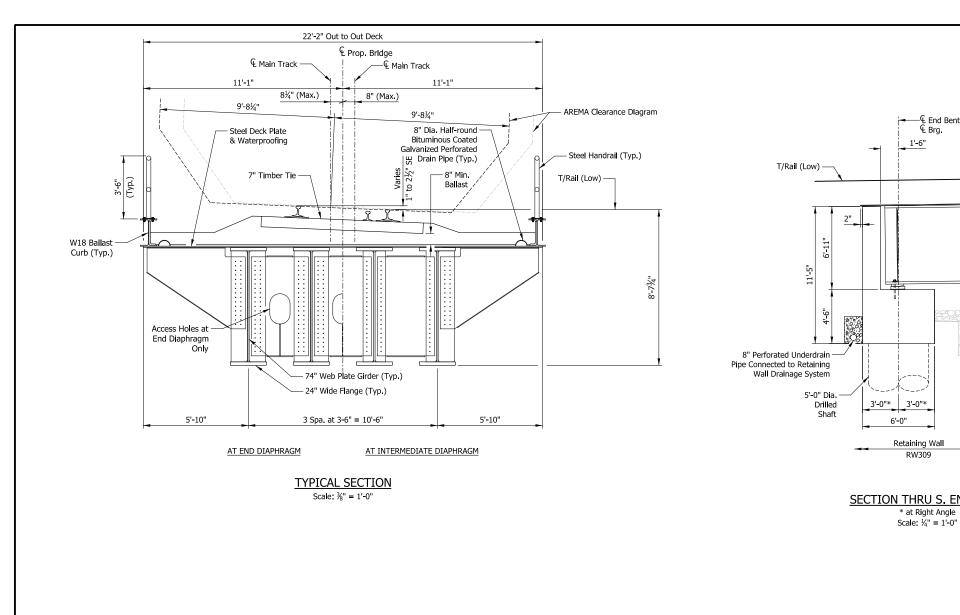
NICTD - WEST LAKE CORRIDOR - MP WL 61.38 TO WL 69.18 SINGLE TRACK **RETAINING WALLS 309W & 309E**


DRAINAGE DETAILS


SHT_WL_ST_RW309_DraInDet_01.dgn 126 OF 218 AS NOTED

FILENAME



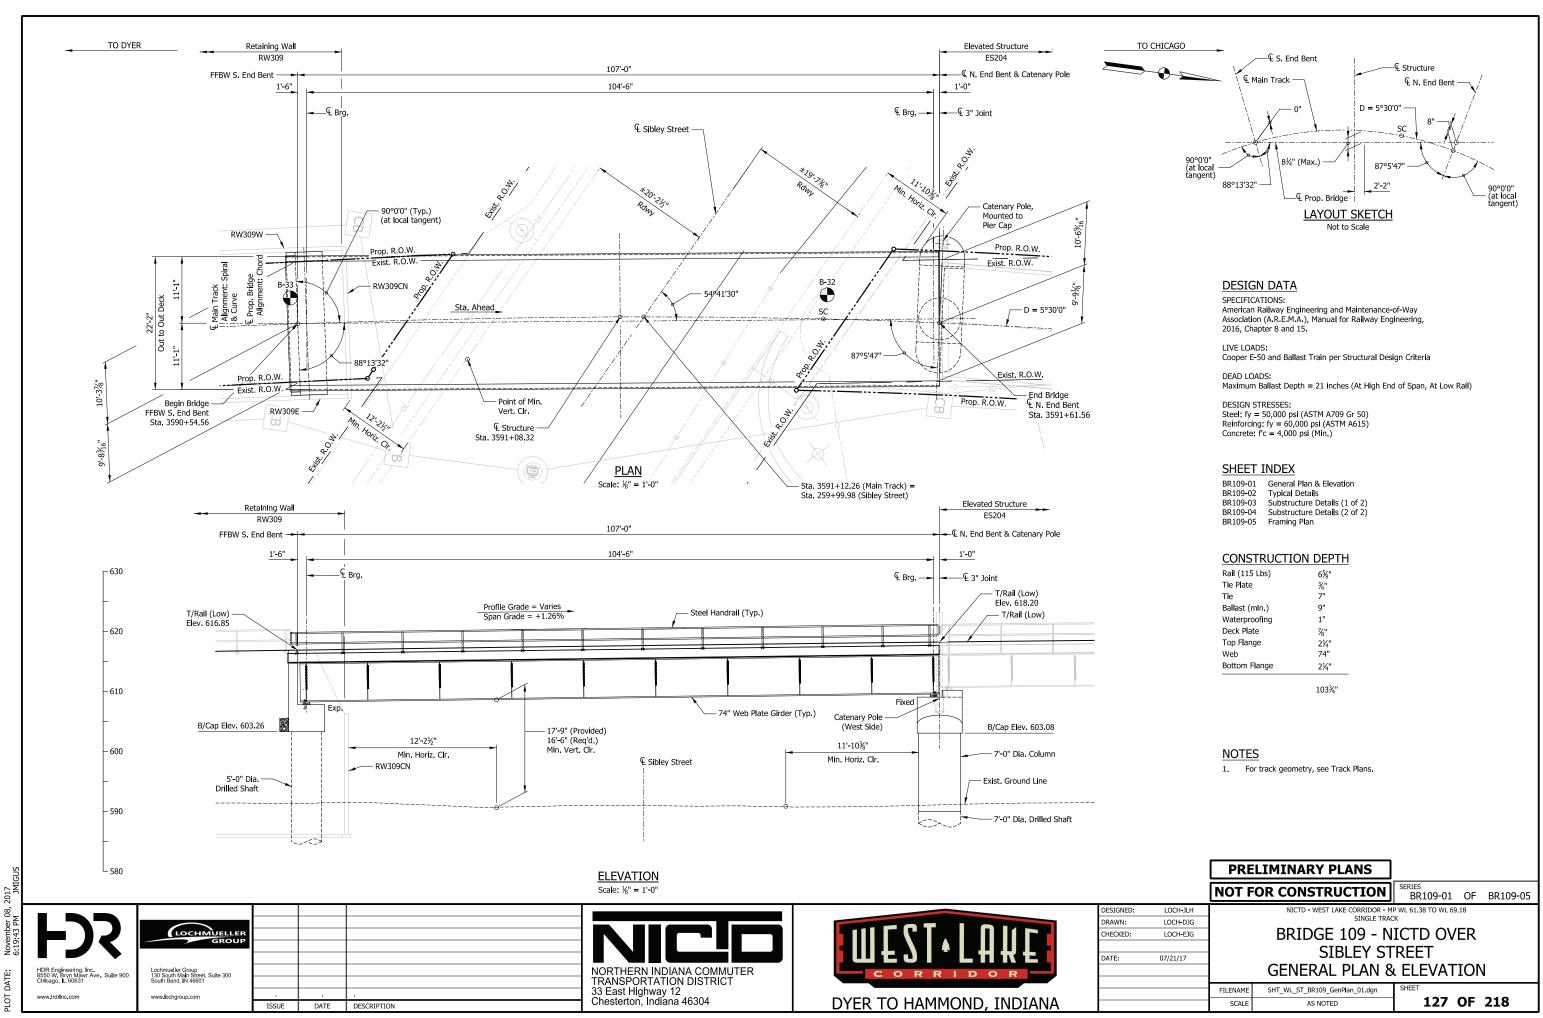


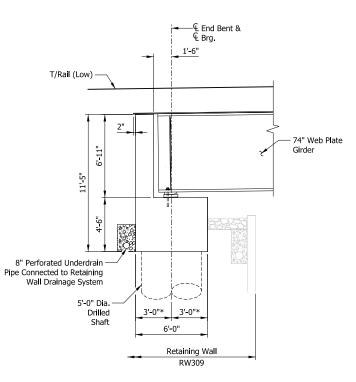


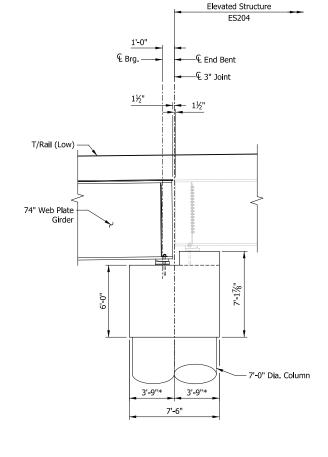


SECTION THRU S. END BENT * at Right Angle

SECTION THRU N. END BENT * at Right Angle Scale: 1/4" = 1'-0"

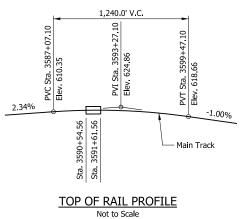

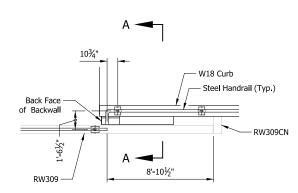

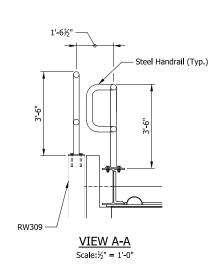

NOTES

PRELIMINARY PLANS

 Outfall from Drainage System to be routed and detailed similar to those provided for Retaining Wall Underdrains.

SERIES BR109-02 OF BR109-05

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HANDRAIL LAYOUT AT BRIDGE SOUTH CORNERS

Scale: 1/4" = 1'-0"




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DRAWN:	LOCH-DJG		SINGLE TRAC	CK
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			SIBLEY ST	-1
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NICTD - WEST LAKE CORRIDOR - MP WL 61.38 TO WL 69.18 SINGLE TRACK BRIDGE 109 - NICTD OVER SIBLEY STREET

TYPICAL DETAILS

SHT_WL_ST_BR109_TypDet_01.dgn 128 OF 218 AS NOTED

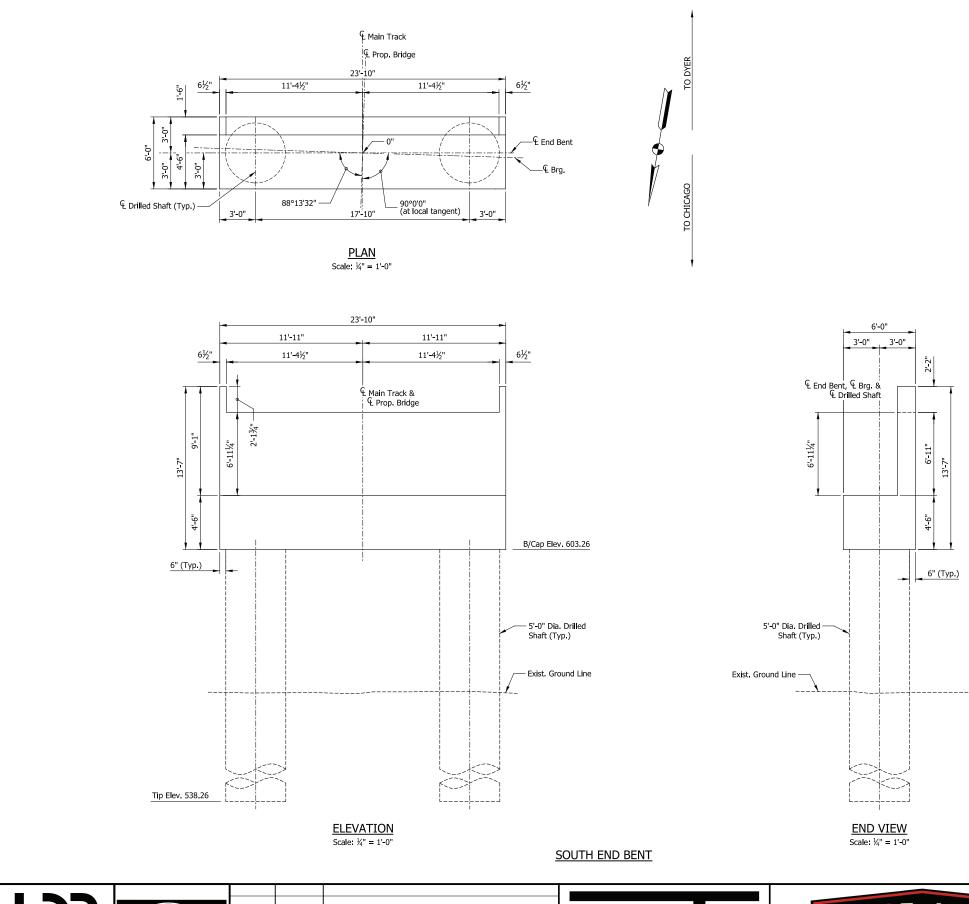

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NICTD - WEST LAKE CORRIDOR - MP WL 61.38 TO WL 69.18 SINGLE TRACK	
BRIDGE 109 - NICTD OVER	
SIBLEY STREET	
SUBSTRUCTURE DETAILS (1 of 2)	

SERIES BR109-03 OF BR109-05

PRELIMINARY PLANS

NOT FOR CONSTRUCTION


FILENAME SHT_WL_ST_BR109_SubstrDet_01.dgn 129 OF 218 SCALE AS NOTED


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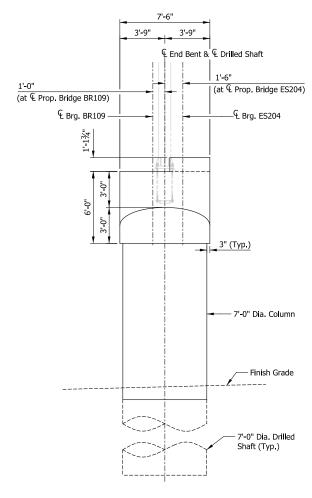
Lochmueller Group 130 South Main Street, Suite 300 South Bend, IN 46601 www.lochgroup.com DATE DESCRIPTION

NORTHERN INDIANA COMMUTER TRANSPORTATION DISTRICT 33 East Highway 12 Chesterton, Indiana 46304

DYER TO HAMMOND, INDIANA



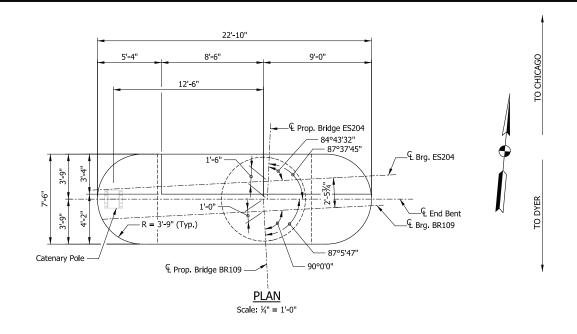

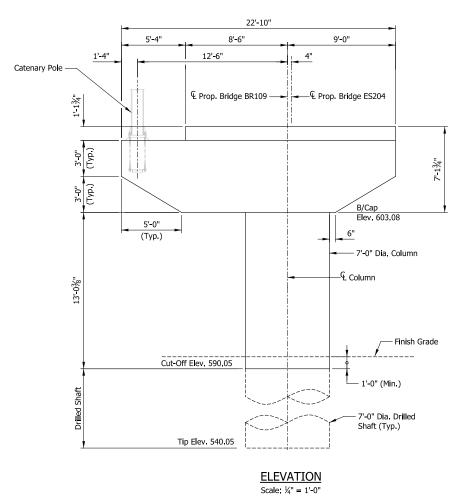

END VIEW
Scale: 1/4" = 1'-0"

NORTH END BENT

Lochmueller Group 130 South Main Street, Suite 300 South Bend, IN 46601 www.lochgroup.com www.hdrinc.com DATE DESCRIPTION







		NOT F	OR CONSTRUCTION	SERIES BR109-04	OF	BR109-05
DESIGNED:	LOCH-JLH		NICTD - WEST LAKE CORRIDOR - M		.18	
DRAWN:	LOCH-DJG		SINGLE TRAC	CK		
CHECKED:	LOCH-EJG	BRIDGE 109 - NICTD OVER				
			SIBLEY ST	DEET		
DATE:	07/21/17					
		SUBSTRUCTURE DETAILS (2 OF 2)				
		FILENAME	SHT_WL_ST_BR109_SubstrDet_02.dgn	SHEET		
		SCALE	AS NOTED	l 130	OF	218


PRELIMINARY PLANS


TO CHICAGO TO DYER 106'-4½" End to End Beam 1'-0" € Brg. __10'-3" 7 Spa. at 12'-0" = 84'-0" Diaphragm & Bracket Spacing 16 Spa. at 6'-0" = 96'-0" 4'-3" Stiffener Spacing 4'-3" ½" Bracket (Typ.) 74" Web Plate Girder 90°0'0" (Typ.) -– 1½" x ¾" Jacking Stiffener (Typ.) 3 Spa. at 3'-6" −¾" End Diaphragm Plate (Typ.) - ½" Intermediate Diaphragm Plate (Typ.) Bearing Stiffener (Typ.) – 6½" x %" Intermediate Stiffener (Typ.) FRAMING PLAN Scale: ½" = 1'-0" 106'-4½" End to End Beam 104'-6" & to & Brg. 1'-0" ---€ Brg. € Brg. -— 24"x2¼" Flange Plate 1" Web Plate (FCM) — Bracket (Typ.) – 24"x2¼" Flange Plate (FCM) **GIRDER EXTERIOR ELEVATION** Scale: ½" = 1'-0" PRELIMINARY PLANS NOT FOR CONSTRUCTION BR109-05 OF BR109-05 NICTD - WEST LAKE CORRIDOR - MP WL 61.38 TO WL 69.18 SINGLE TRACK LOCH-JLH DRAWN: LOCH-DJG BRIDGE 109 - NICTD OVER HECKED: LOCH-EJG SIBLEY STREET DATE: 07/21/17 NORTHERN INDIANA COMMUTER TRANSPORTATION DISTRICT 33 East Highway 12 Chesterton, Indiana 46304 FRAMING PLAN 130 South Main Street, Suite 300 South Bend, IN 46601 FILENAME SHT_WL_ST_BR109_FramPlan_01.dgn www.hdrinc.com www.lochgroup.com 131 OF 218 DYER TO HAMMOND, INDIANA AS NOTED DATE DESCRIPTION

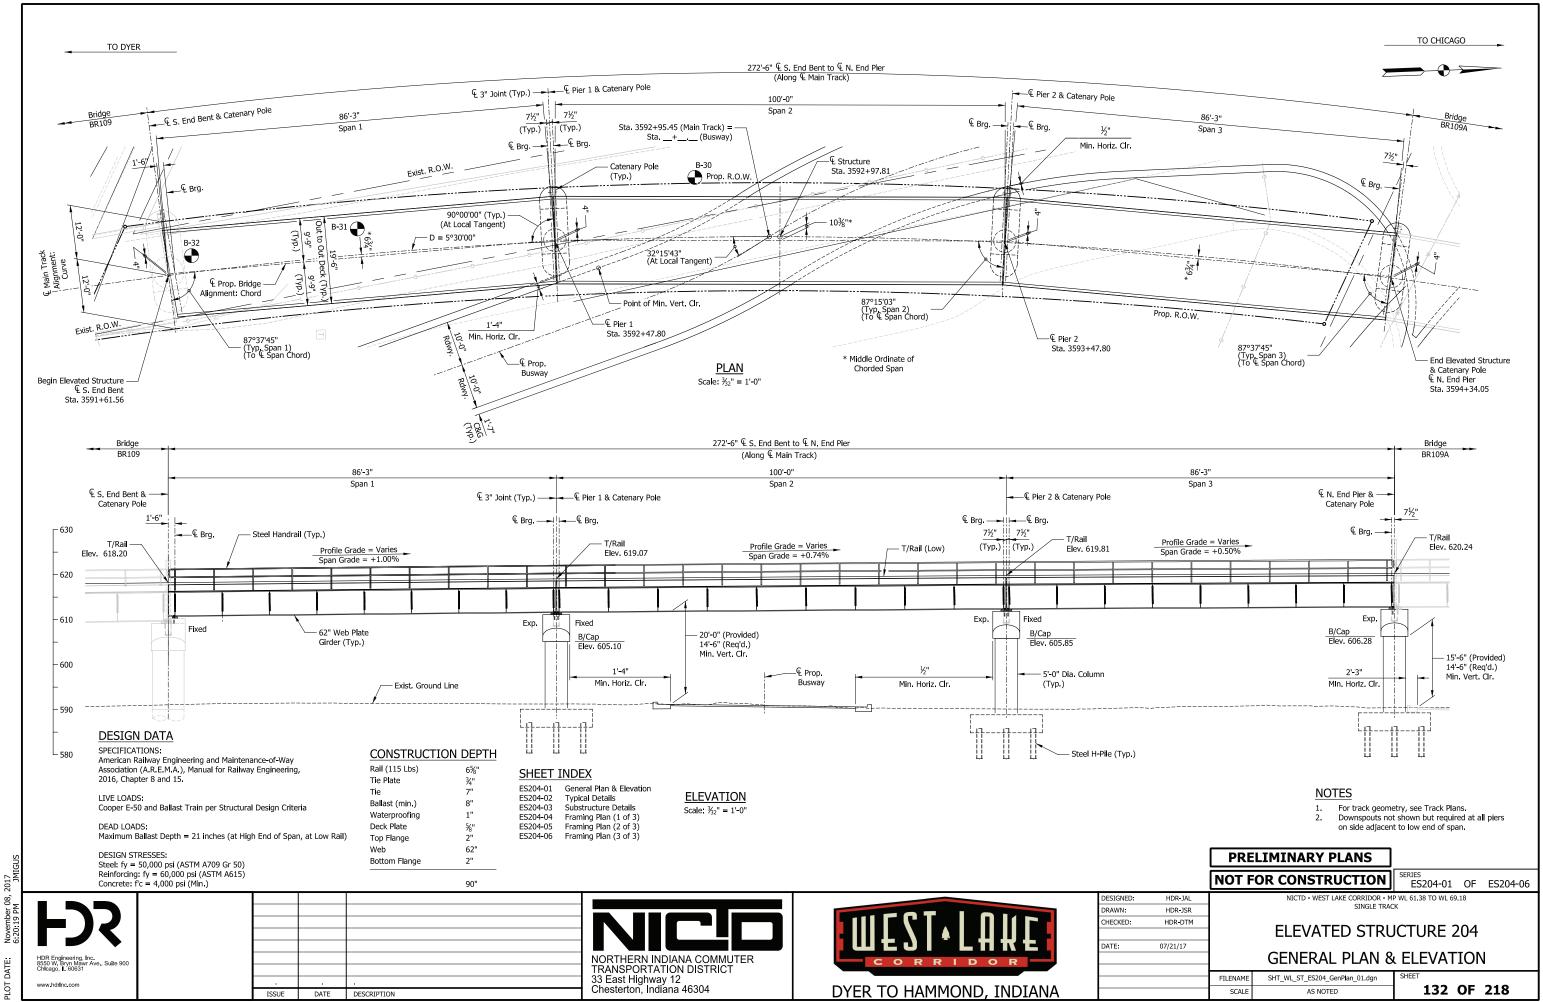

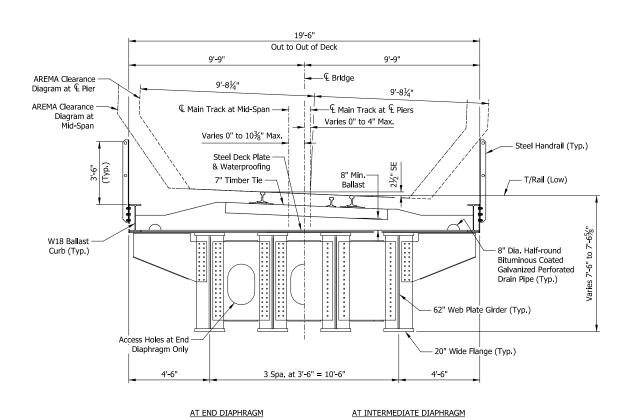

TYPICAL SECTION Scale: 3/8" = 1'-0"

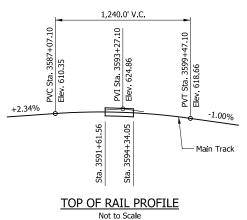

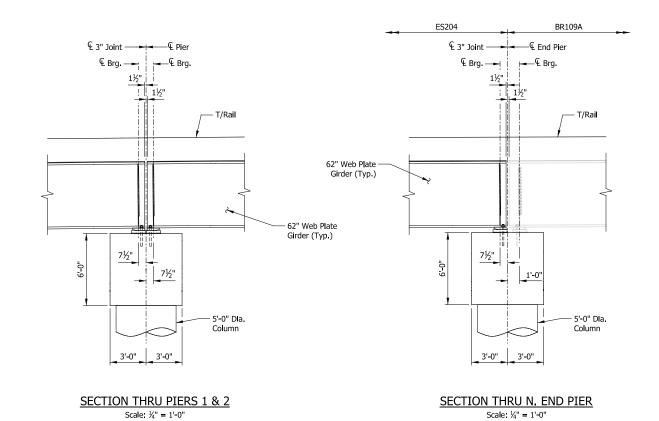

		NOT FOR CONSTRUCTION
DESIGNED:	HDR-JAL	NICTD - WEST LAKE CORRIDOR - MP
DRAWN:	HDR-JSR	SINGLE TRACK
CHECKED:	HDR-DTM	ELEVATED CEDIA
		ELEVATED STRU
DATE:	07/21/17	
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NICTD - WEST LAKE CORRIDOR - MP WL 61.38 TO WL 69.18 SINGLE TRACK

PRELIMINARY PLANS


FILENAME

ELEVATED STRUCTURE 204 TYPICAL SECTION

SHT_WL_ST_ES204_TypDet_01.dgn 133 OF 218 AS NOTED


ES204-02 OF ES204-06


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NORTHERN INDIANA COMMUTER TRANSPORTATION DISTRICT 33 East Highway 12 Chesterton, Indiana 46304

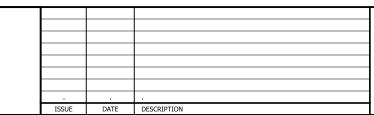DYER TO HAMMOND, INDIANA



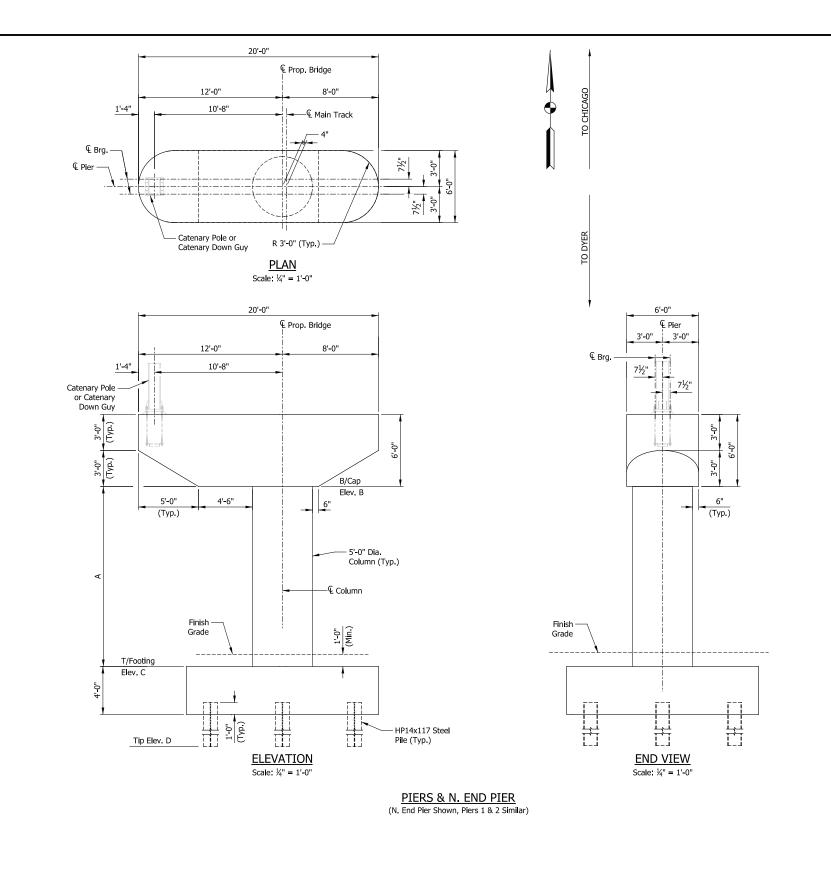

FOOTING PLAN (TYP.)
Scale: ½" = 1'-0"

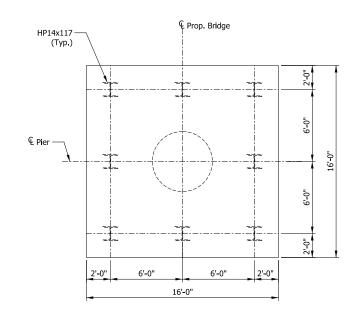GEOMETRY TABLE				
LOCATION	Dim. A	Elev. B	Elev. C	Elev. D
Pier 1	15'-0"	605.10	590.10	494.10
Pier 2	17'-0"	605.85	588.85	492.85
N. End Pier	17'-0"	606.28	589.28	490.28

PRELIMINARY PLANS

NOT FOR CONSTRUCTION

HDR-JSR

HDR-DTM

07/21/17

ORAWN: CHECKED:

DATE:

ES204-03 OF ES204-06

NICTD - WEST LAKE CORRIDOR - MP WL 61.38 TO WL 69.18 SINGLE TRACK

ELEVATED STRUCTURE 204

SUBSTRUCTURE DETAILS

HDR Engineering, Inc. 8550 W. Bryn Mawr Ave., Suite 900 Chrisago, I. 20031

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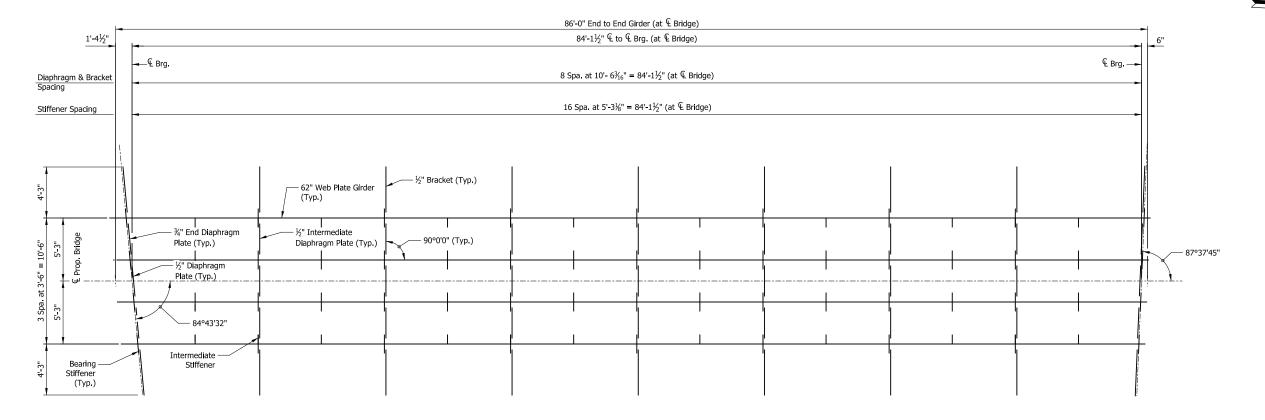
ISSUE DATE DESCRIPTION

NORTHERN INDIANA COMMUTER TRANSPORTATION DISTRICT 33 East Highway 12 Chesterton, Indiana 46304




TO DYER

TO CHICAGO



FRAMING PLAN Span 1 Scale: ½" = 1'-0"

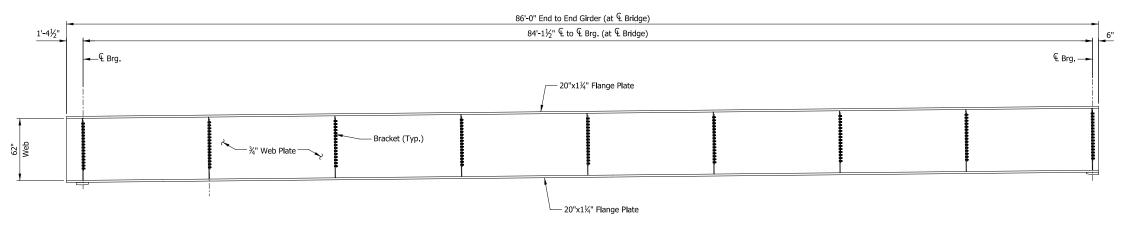

BEAM EXTERIOR ELEVATION

Scale: ½" = 1'-0"

PRELIMINARY PLAN	S
NOT FOR CONSTRUCT	ION

FOR CONSTRUCTION SERIES ES204-04 OF ES204-06 NICTD - WEST LAKE CORRIDOR - MP WL 61.38 TO WL 69.18 SINGLE TRACK

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ISSUE DATE DESCRIPTION

NORTHERN INDIANA COMMUTER TRANSPORTATION DISTRICT 33 East Highway 12 Chesterton, Indiana 46304




DESIGNED:	HDR-JAL		
DRAWN:	HDR-JSR		
CHECKED:	HDR-DTM		
DATE:	07/21/17		
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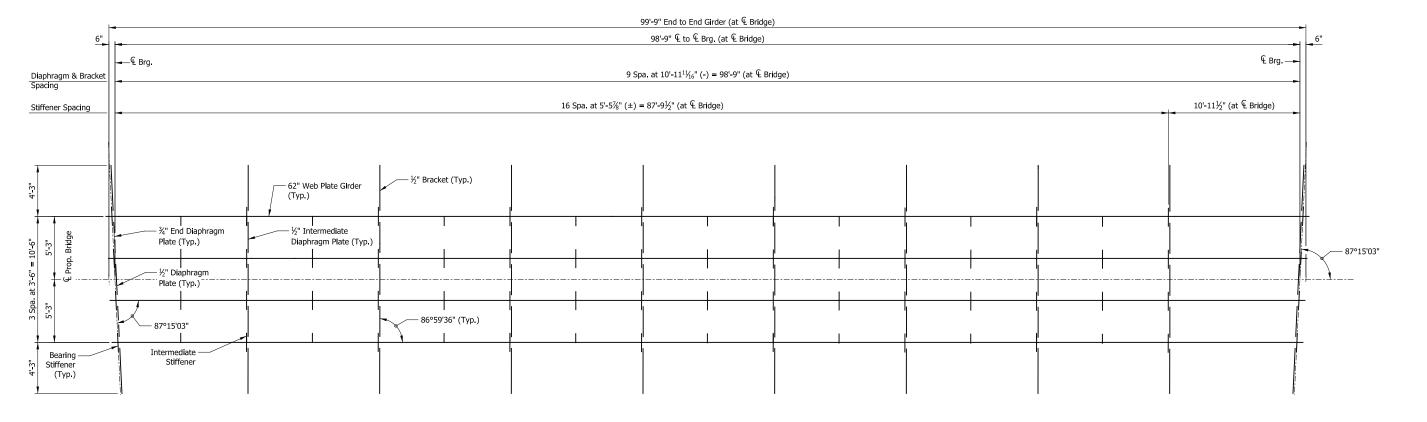
ELEVATED STRUCTURE 204 FRAMING PLAN (1 OF 3)

SHT_WL_ST_ES204_FramPlan_01.dgn


135 OF 218 AS NOTED



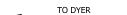



FRAMING PLAN Span 2 Scale: ½" = 1'-0"

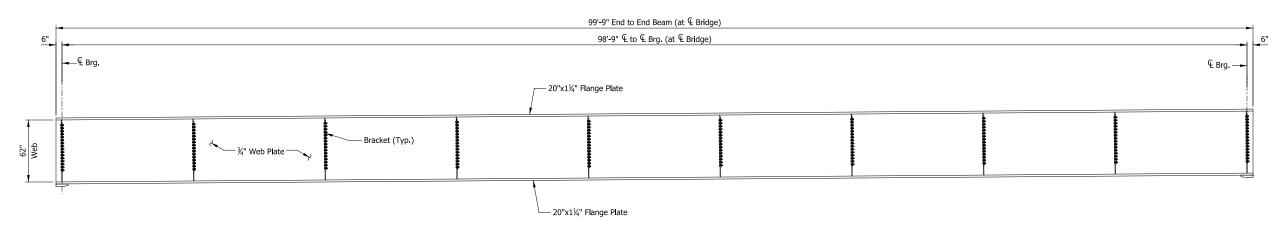

BEAM EXTERIOR ELEVATION Span 2 Scale: ¼" = 1'-0"

PR	ELIN	1INARY	PLANS
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NOT FOR CONSTRUCTION ES204-05 OF ES204-06

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NORTHERN INDIANA COMMUTER TRANSPORTATION DISTRICT 33 East Highway 12 Chesterton, Indiana 46304




DATE:	07/21/17	
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DRAWN:	HDR-JSR	
DESIGNED:	HDR-JAL	

NICTD - WEST LAKE CORRIDOR - MP WL 61.38 TO WL 69.18 SINGLE TRACK **ELEVATED STRUCTURE 204** FRAMING PLAN (2 OF 3)


FILENAME SHT_WL_ST_ES204_FramPlan_02.dgn 136 OF 218 AS NOTED

TO DYER

TO CHICAGO

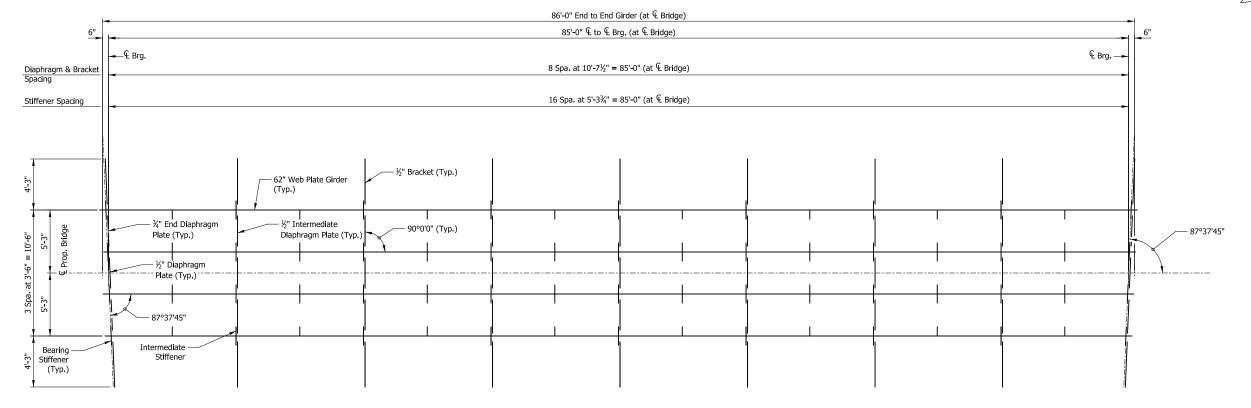

FRAMING PLAN Span 3 Scale: ½" = 1'-0"

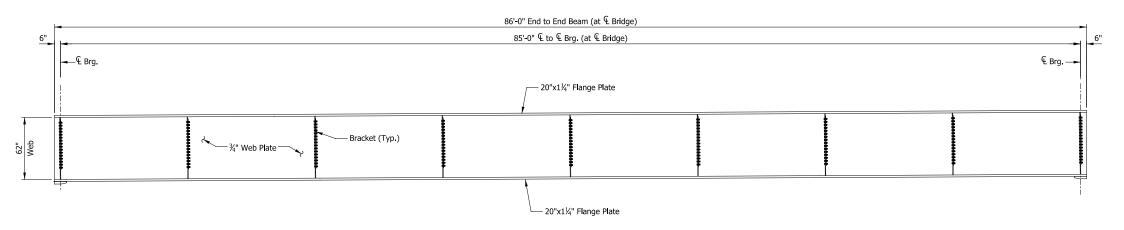

BEAM EXTERIOR ELEVATION

Scale: ½" = 1'-0"

PRELIMINARY PLANS			
OT FOR CONSTRUCTION			

SERIES ES204-06 OF ES204-06

137 OF 218

NORTHERN INDIANA COMMUTER TRANSPORTATION DISTRICT 33 East Highway 12 Chesterton, Indiana 46304

ISSUE DATE DESCRIPTION




DESIGNED:	HDR-JAL
DRAWN:	HDR-JSR
CHECKED:	HDR-DTM
DATE:	07/21/17
	DRAWN: CHECKED:

NICTD - WEST LAKE CORRIDOR - MP WL 61.38 TO WL 69.18	HDR-JAL	GNED:
SINGLE TRACK	HDR-JSR	WN:
ELEVATED STRUCTURE 204	HDR-DTM	CKED:
FRAMING PLAN (3 OF 3)	07/21/17	:
FILENAME SHT WL ST ES204 FramPlan 03.dgn SHEET	FI	

AS NOTED

SCALE

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DYER TO HAMMOND, INDIANA

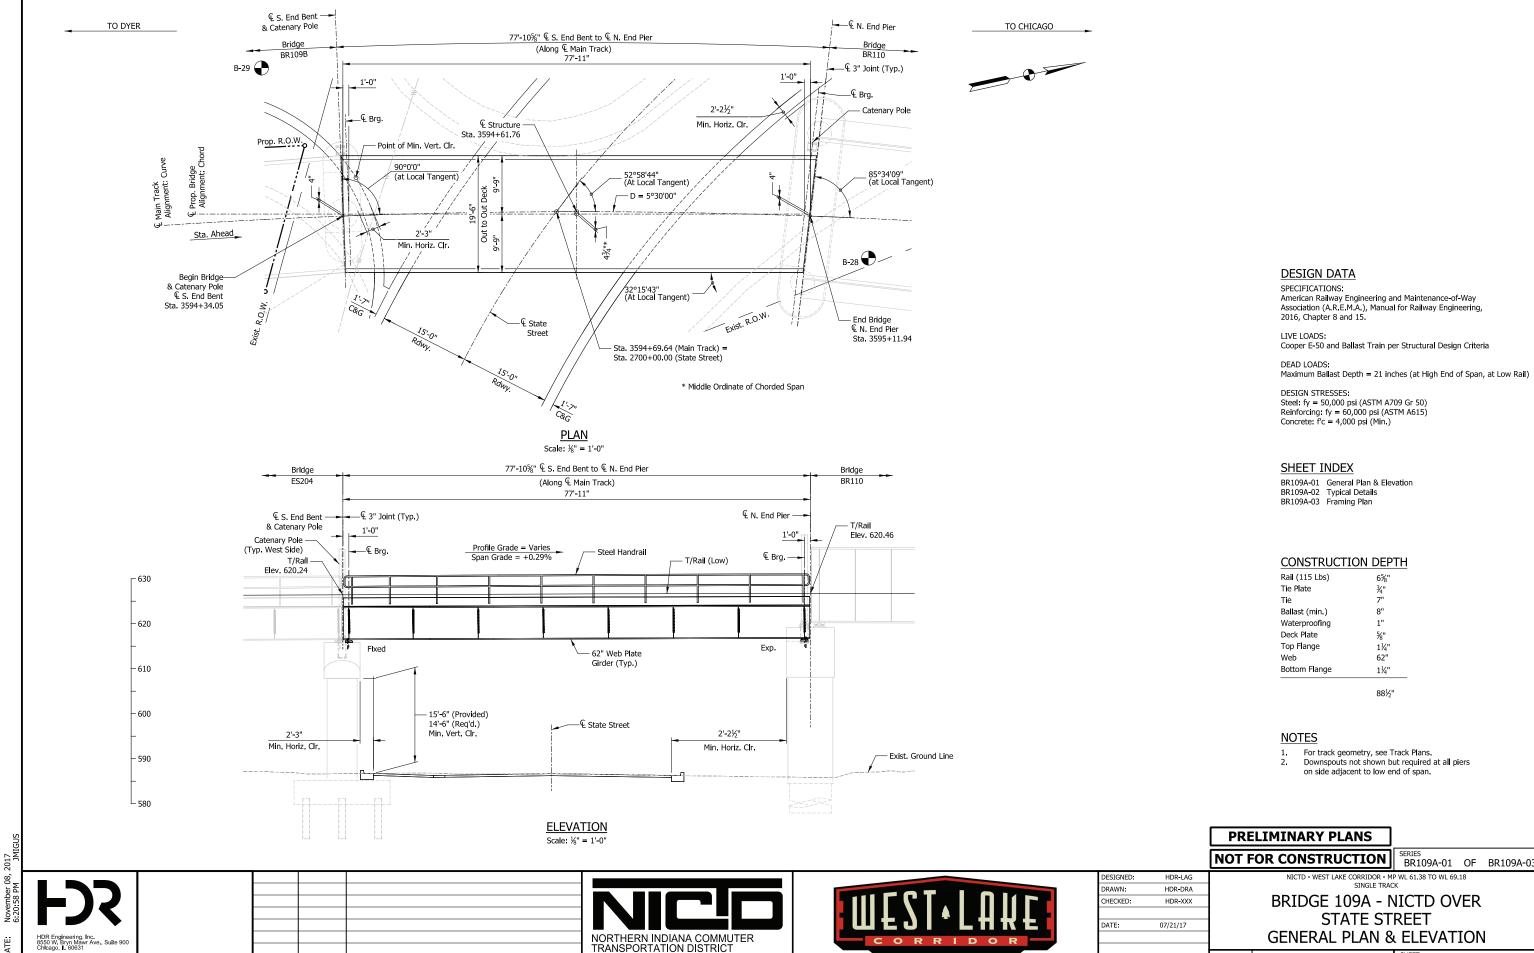SHT_WL_ST_BR109A_GenPlan_01.dgn


AS NOTED

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33 East Highway 12 Chesterton, Indiana 46304

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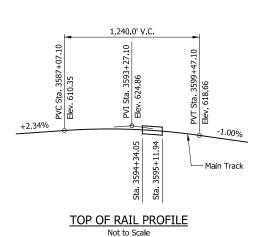
DATE DESCRIPTION



TYPICAL SECTION Scale: 3/8" = 1'-0"

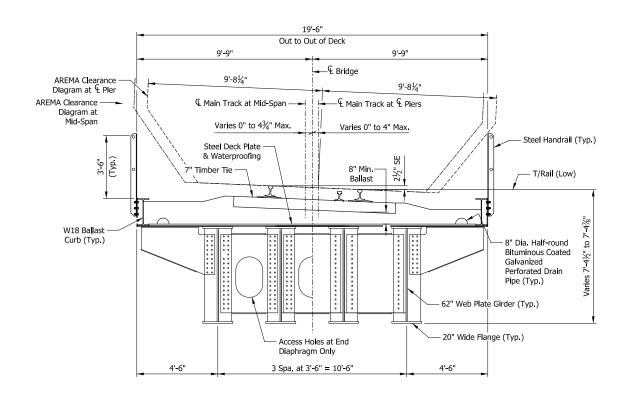
AT INTERMEDIATE DIAPHRAGM

AT END DIAPHRAGM



ES204 BR109A —€ End Bent £ 3" Joint — -← £ Brg. 1'-0" 1½" – T/Rail 1½" 62" Web Plate

SECTION THRU SOUTH END BENT

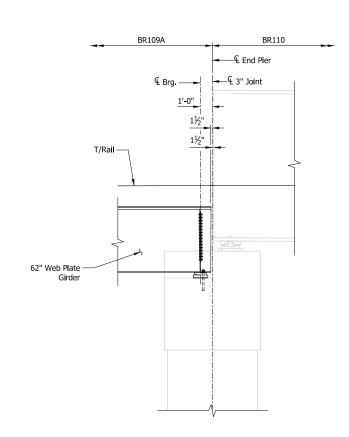

SECTION THRU NORTH END PIER Scale: ½" = 1'-0"

PRELIMINARY PLANS

NOT FOR CONSTRUCTION BR109A-02 OF BR109A-03 NICTD - WEST LAKE CORRIDOR - MP WL 61.38 TO WL 69.18 SINGLE TRACK

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NORTHERN INDIANA COMMUTER TRANSPORTATION DISTRICT 33 East Highway 12 Chesterton, Indiana 46304




DATE:	07/21/17	
CHECKED:	HDR-DTM	
DRAWN:	HDR-DRA	
DESIGNED:	HDR-LAG	

BRIDGE 109A - NICTD OVER STATE STREET TYPICAL SECTION


> FILENAME SHT_WL_ST_BR109A_TypDet_01.dgn 139 OF 218 AS NOTED

TO DYER

TO CHICAGO

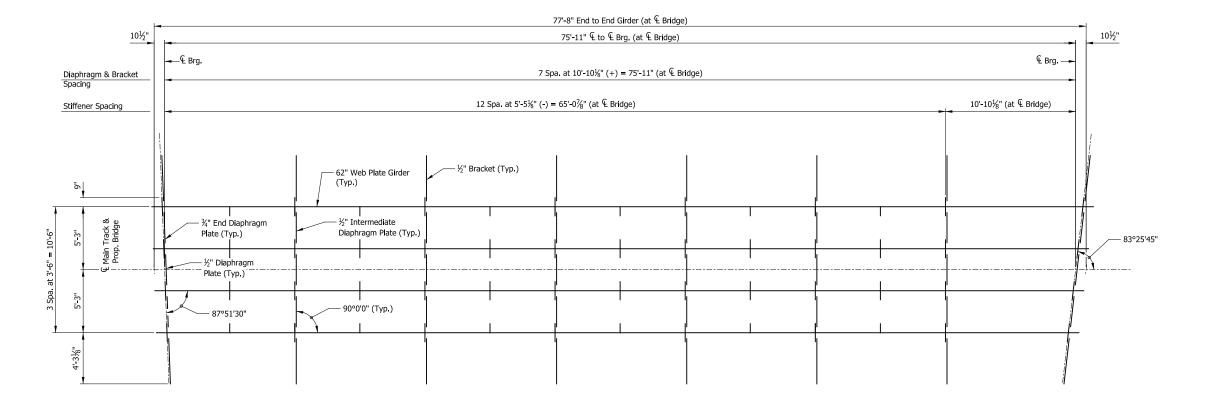

FRAMING PLAN Scale: ½" = 1'-0"

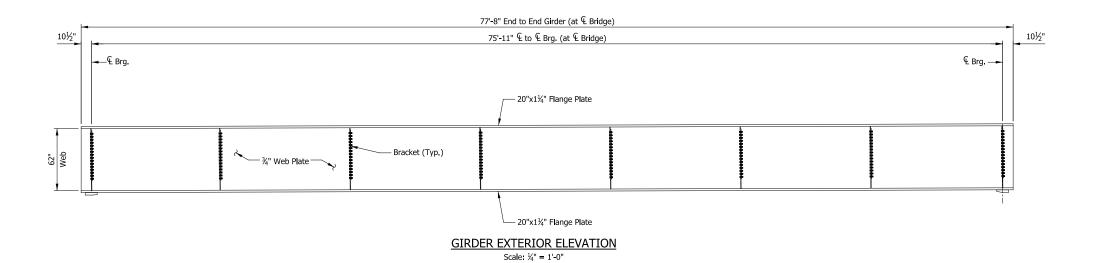

www.hdrinc.com DATE DESCRIPTION





DESIGNED:	HDR-LAG	
DRAWN:	HDR-DRA	1
CHECKED:	HDR-XXX	1
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DATE:	07/21/17	1
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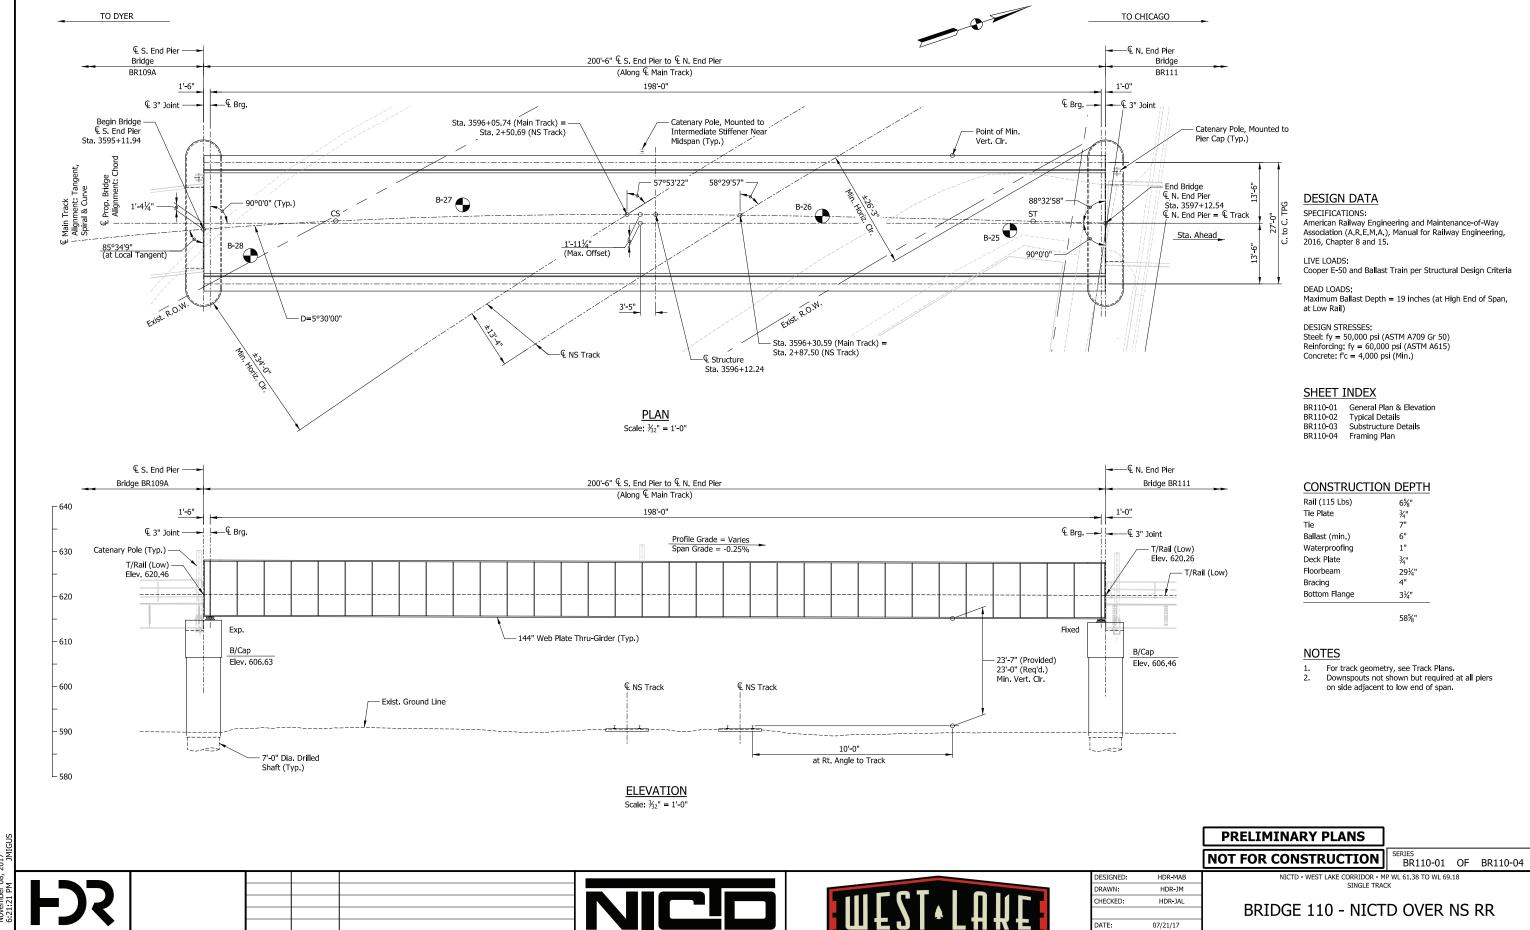
NOT FOR CONSTRUCTION SERIES BR109A-03 OF BR109A-03 NICTD - WEST LAKE CORRIDOR - MP WL 61.38 TO WL 69.18 SINGLE TRACK BRIDGE 109A - NICTD OVER

STATE STREET FRAMING PLAN

FILENAME SHT_WL_ST_BR109A_FramPlan_01.dgn AS NOTED

PRELIMINARY PLANS

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NORTHERN INDIANA COMMUTER TRANSPORTATION DISTRICT 33 East Highway 12 Chesterton, Indiana 46304

07/21/17

DYER TO HAMMOND, INDIANA

GENERAL PLAN & ELEVATION


141 OF 218


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TOP OF RAIL PROFILE Not to Scale

DATE DESCRIPTION

		_
DESIGNED:	HDR-MAB	
DRAWN:	HDR-JM	
CHECKED:	HDR-JAL	
DATE:	07/21/17	
		_

SERIES BR110-02 OF BR110-04 NOT FOR CONSTRUCTION NICTD - WEST LAKE CORRIDOR - MP WL 61.38 TO WL 69.18 SINGLE TRACK

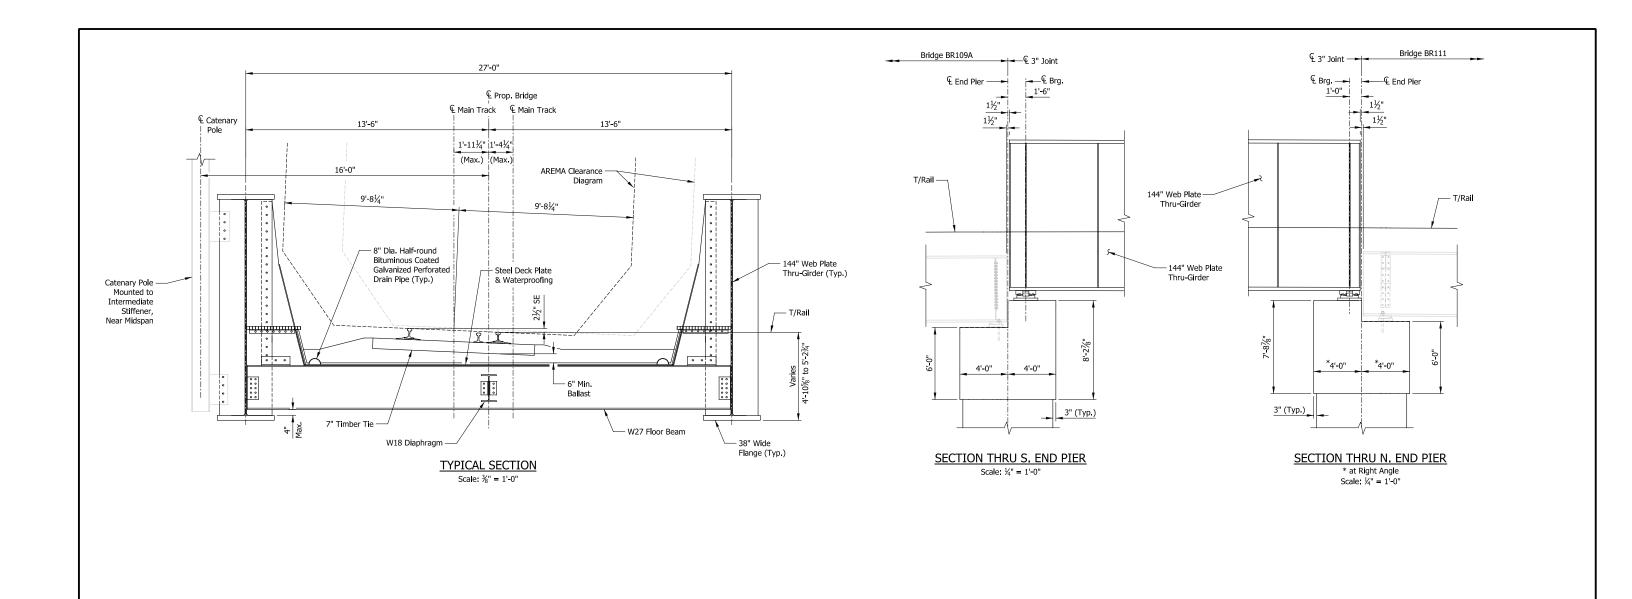PRELIMINARY PLANS

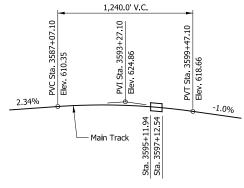
BRIDGE 110 - NICTD OVER NS RR TYPICAL DETAILS

FILENAME SHT_WL_ST_BR110_TypDet_01.dgn 142 OF 218 AS NOTED

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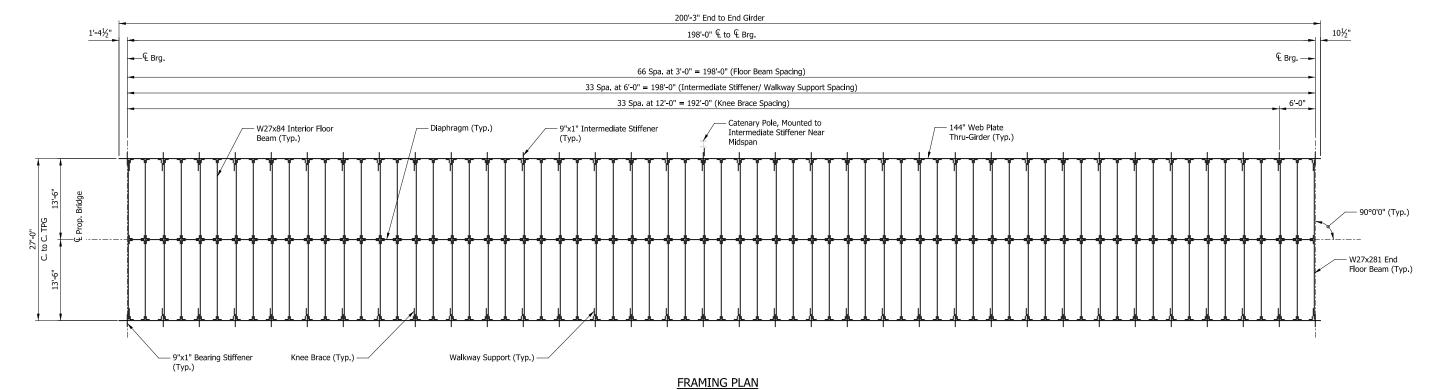
DYER TO HAMMOND, INDIANA




TO DYER

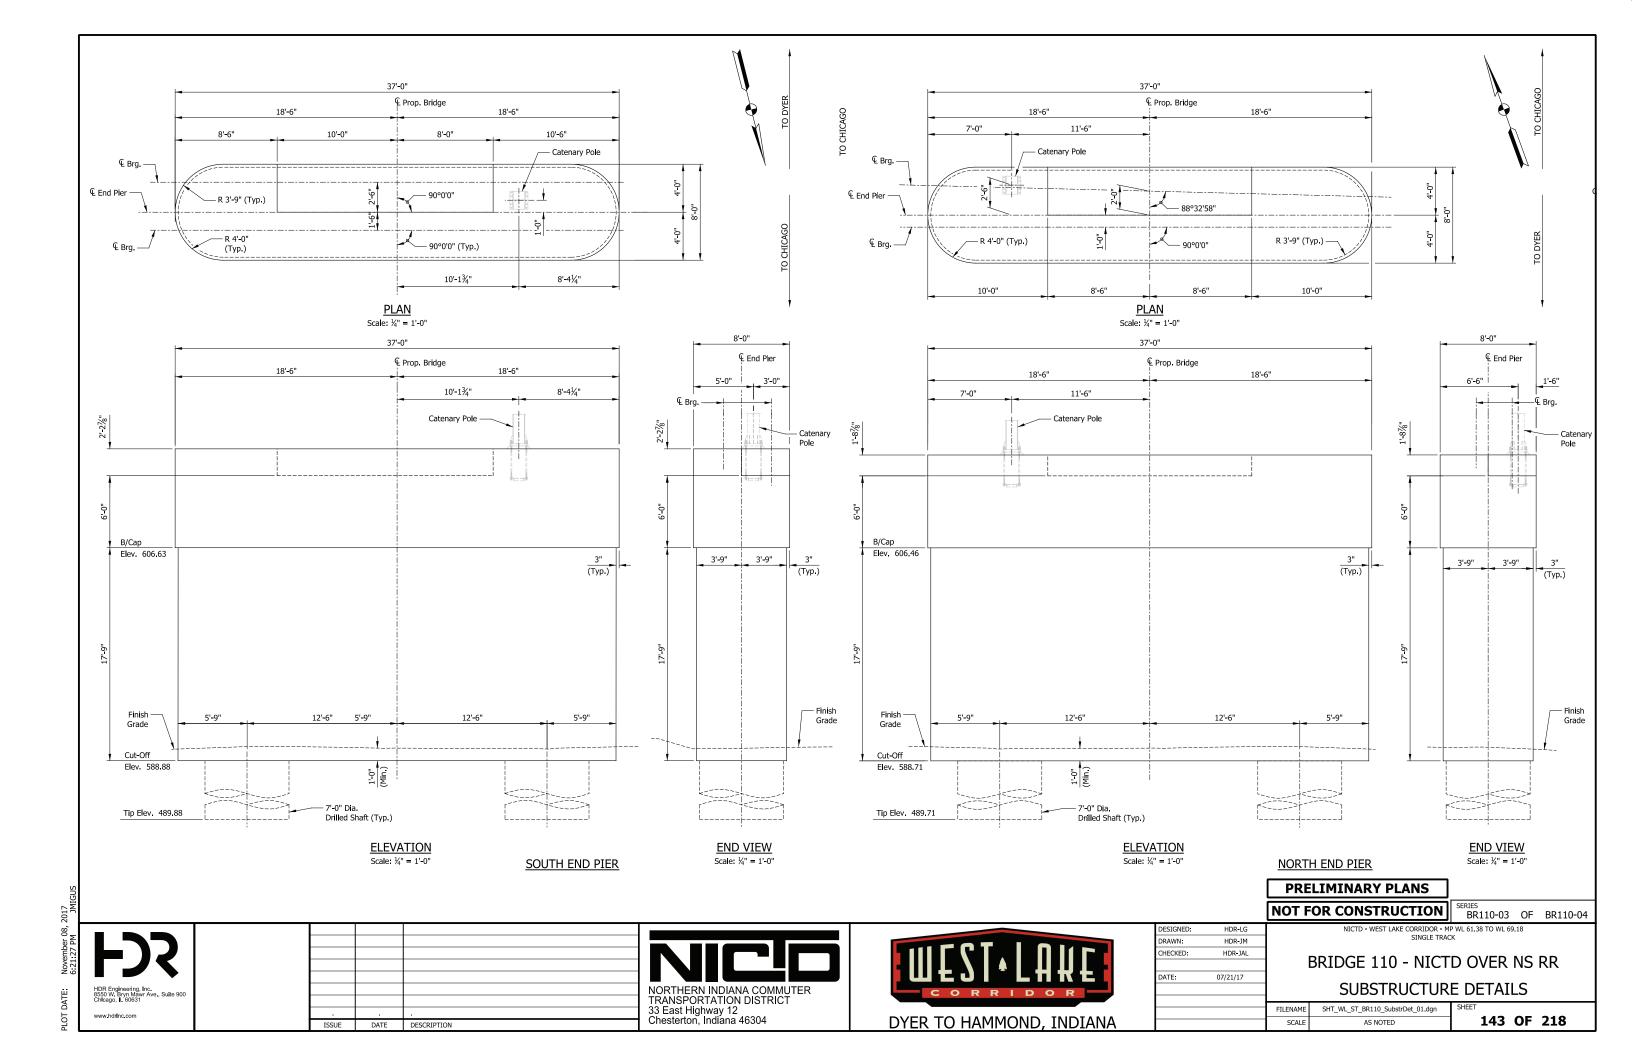

TO CHICAGO



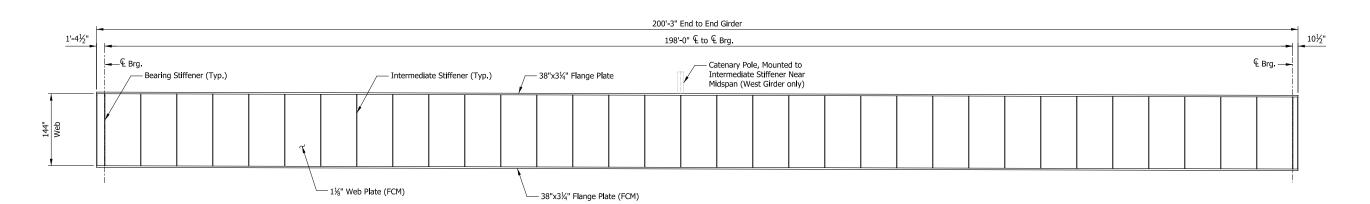

Scale: 1/8" = 1'-0"

GIRDER EXTERIOR ELEVATION

Scale: ½" = 1'-0"

PR	RELIN	MIN	ARY	PLAN	IS

NOT FOR CONSTRUCTION

BR110-04 OF BR110-04

HDR Engineering, Inc. 8550 W. Bryn Mawr Ave., Suite 900 Chicago, IL 60631 www.hdrinc.com ISSUE DATE DESCRIPTION



MESI. LAHE
DYER TO HAMMOND, INDIANA

DESIGNED: HDR-MAB	
DRAWN: HDR-JM	
CHECKED: HDR-JAL	
DATE: 07/21/17	П

BRIDGE 110 - NICTD OVER NS RR

FRAMING PLAN

T DATE Nov

TE: November

TO DYER TO CHICAGO € S. End Pier ----——€ N. End Pier 83'-6" Bridge Bridge BR110 BR112 1'-6" € Brg. -**→**—€ Brg. ±2'-51/3" C&G Rdwv ±20'-51/3" ±2|-1½" Rdwy Begin Bridge • Exist. · € Willow Court Sta. 3597+12.54 26'-7" Min. Horiz. Clr. Point of Min. Vert. Clr. – End Bridge € N, End Pier 90°0'0" - 82°44'26" Sta 3597+96.04 B-24 - 88°32'58 Sta. Ahead_ € Structure Sta. 3597+54.29 - Sta. 3597+43.82 (Main Track) = Sta. 2800+00.00 (Willow Court) <u>PLAN</u> Scale: 1/8" = 1'-0" € S. End Pier — ——

¶

N. End Pier 83'-6" Bridge Bridge BR110 BR112 2'-0" 1'-6" € Brg — ← € 3" Joint € 3" Joint Elev. 620.26 - 630 Steel Handrail (Typ.) Profile Grade = Varies
Span Grade = -0.488% Elev. 619.86 - T/Rail - 620 – Pier Cap Fixed - 610 (Typ.) - 60" Web Plate Girder (Typ.) B/Cap 22'-6" (Provided) -14'-6" (Req'd.) Min. Vert. Clr. Elev. 606.07 4'-5" - 600 - Pier Wall € Willow Court Min. Horiz. Clr. (Typ.) 26'-7" Min. Horiz. Clr. ---- Exist. Ground Line L 590 – 5'-0" Dia. **ELEVATION** Drilled Shaft Scale: 1/8" = 1'-0"

DESIGN DATA

SPECIFICATIONS:

American Railway Engineering and Maintenance-of-Way Association (A.R.E.M.A.), Manual for Railway Engineering, 2016, Chapter 8 and 15.

LIVE LOADS: Cooper E-50 and Ballast Train per Structural Design Criteria

DEAD LOADS:

Maximum Ballast Depth = 21 inches (at High End of Span)

Steel: fy = 50,000 psi (ASTM A709 Gr 50) Reinforcing: fy = 60,000 psi (ASTM A615) Concrete: f'c = 4,000 psi (Min.)

SHEET INDEX

BR111-01 General Plan & Elevation BR111-02 Typical Details BR111-03 Substructure Details

BR111-04 Framing Plan

CONSTRUCTION CONST	<u>ON DEPT</u>
Rail (115 Lbs)	6%"
Tie Plate	3/4"
Tie	7"
Ballast (min.)	8"
Waterproofing	1"
Deck Plate	5⁄8"
Top Flange	2"
Web	60"
Bottom Flange	2"

DESIGNED:

HDR-JM

HDR-RVC

07/21/17

DRAWN:

DATE:

HECKED:

- For track geometry, see Track Plans. Downspouts not shown but required at all piers
- on side adjacent to low end of span.

PRELIMINARY PLANS

NOT FOR CONSTRUCTION

SERIES BR111-01 OF BR111-04

NICTD - WEST LAKE CORRIDOR - MP WL 61.38 TO WL 69.18 SINGLE TRACK

BRIDGE 111 - NICTD OVER WILLOW COURT

GENERAL PLAN & ELEVATION SHT_WL_ST_BR111_GenPlan_01.dgn AS NOTED

145 OF 218


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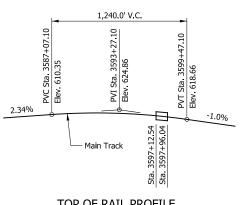
NORTHERN INDIANA COMMUTER TRANSPORTATION DISTRICT 33 East Highway 12 Chesterton, Indiana 46304



DYER TO HAMMOND, INDIANA



TYPICAL SECTION

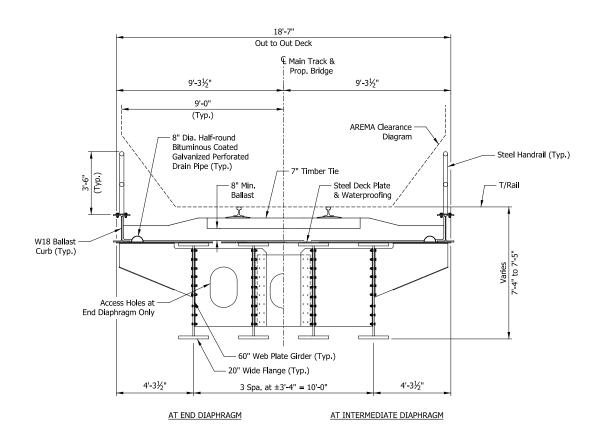

TOP OF RAIL PROFILE Not to Scale

DATE DESCRIPTION





60" Web Plate Girder

		NOT	•
DESIGNED:	HDR-EJW		•
DRAWN:	HDR-JM	1	
CHECKED:	HDR-RVC		
DATE:	07/21/17		
		J	
		FILENAME	

Bridge BR112

6" (Typ.)

€ Brg. — 1'-6"_

3'-6"

SECTION THRU N. END PIER

Scale: 1/4" = 1'-0"


NICTD - WEST LAKE CORRIDOR - MP WL 61.38 TO WL 69.18 SINGLE TRACK BRIDGE 111 - NICTD OVER WILLOW COURT TYPICAL DETAILS

SHT_WL_ST_BR111_TypDet_01.dgn 146 OF 218 AS NOTED

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NOT FOR CONSTRUCTION BR111-02 OF BR111-04

PRELIMINARY PLANS

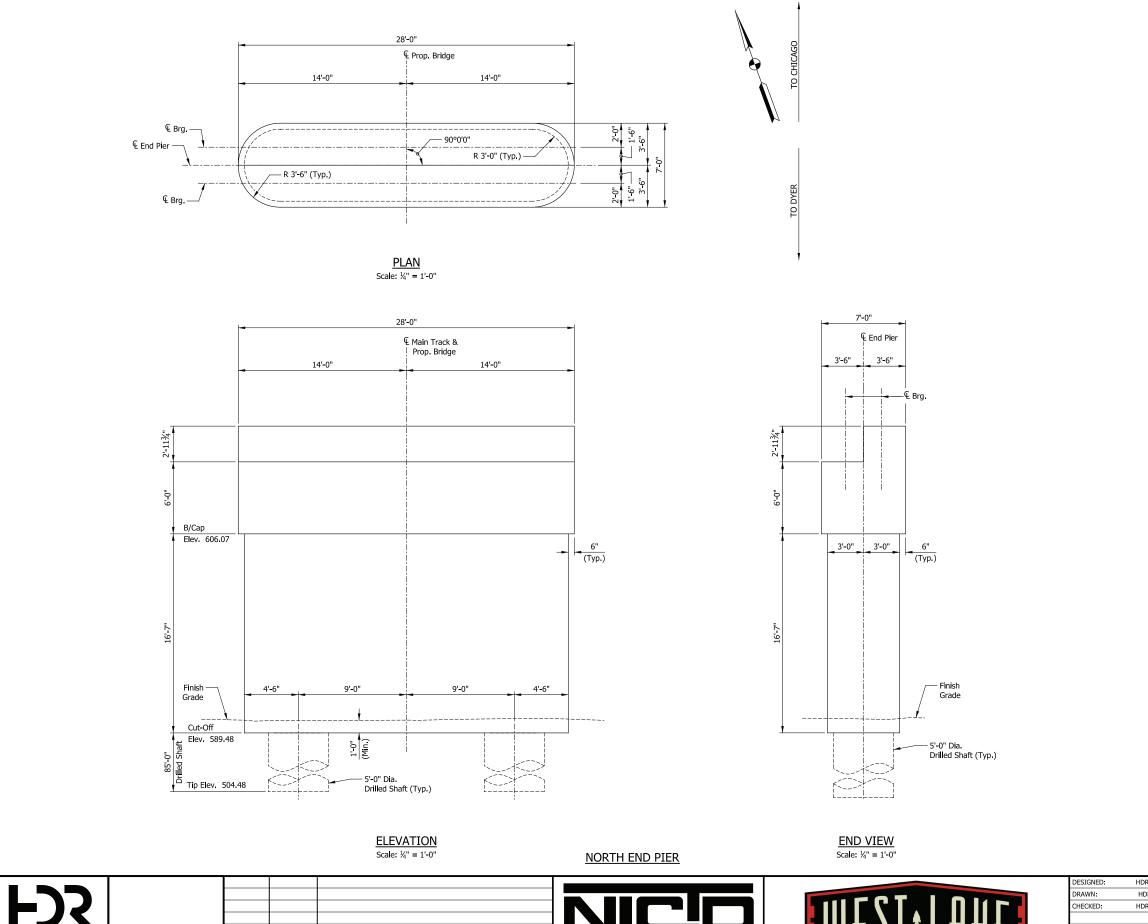

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DESIGNED:	HDR-EJW		
DRAWN:	HDR-JM		
CHECKED:	HDR-RVC		
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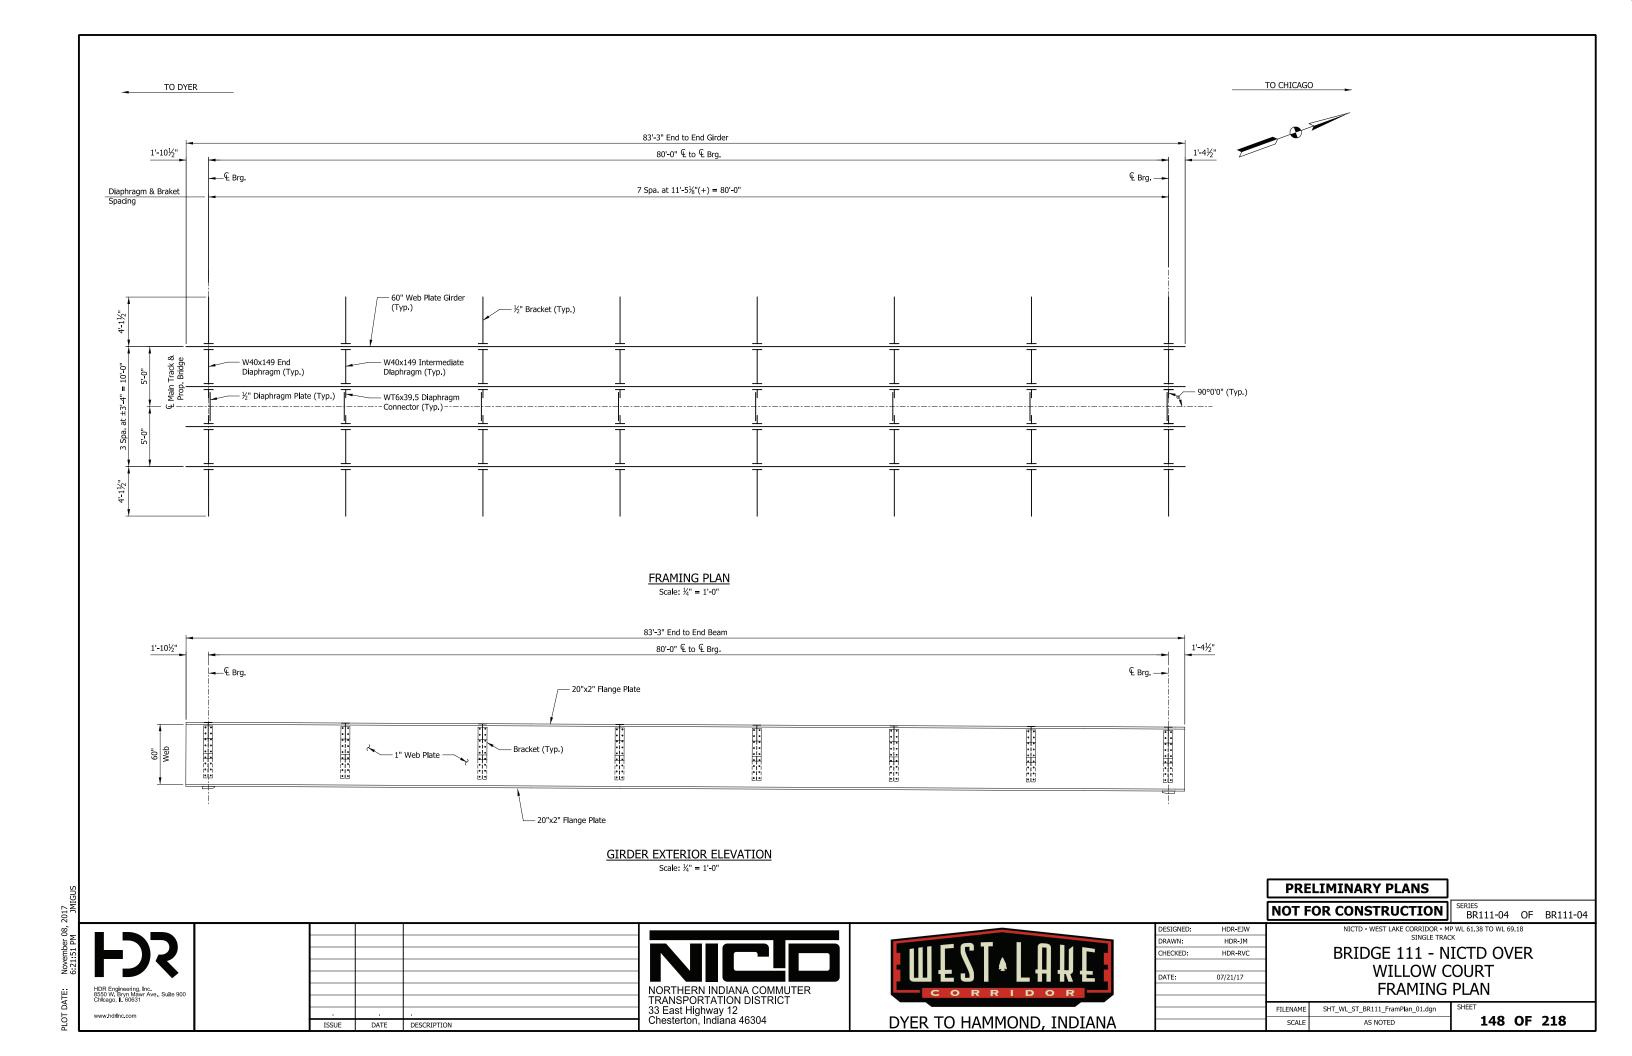
NOT FOR CONSTRUCTION SERIES BR111-03 OF BR111-04 NICTD - WEST LAKE CORRIDOR - MP WL 61.38 TO WL 69.18 SINGLE TRACK


BRIDGE 111 - NICTD OVER


WILLOW COURT SUBSTRUCTURE DETAILS

PRELIMINARY PLANS


SHT_WL_ST_BR111_SubstrDet_01.dgn 147 OF 218 AS NOTED



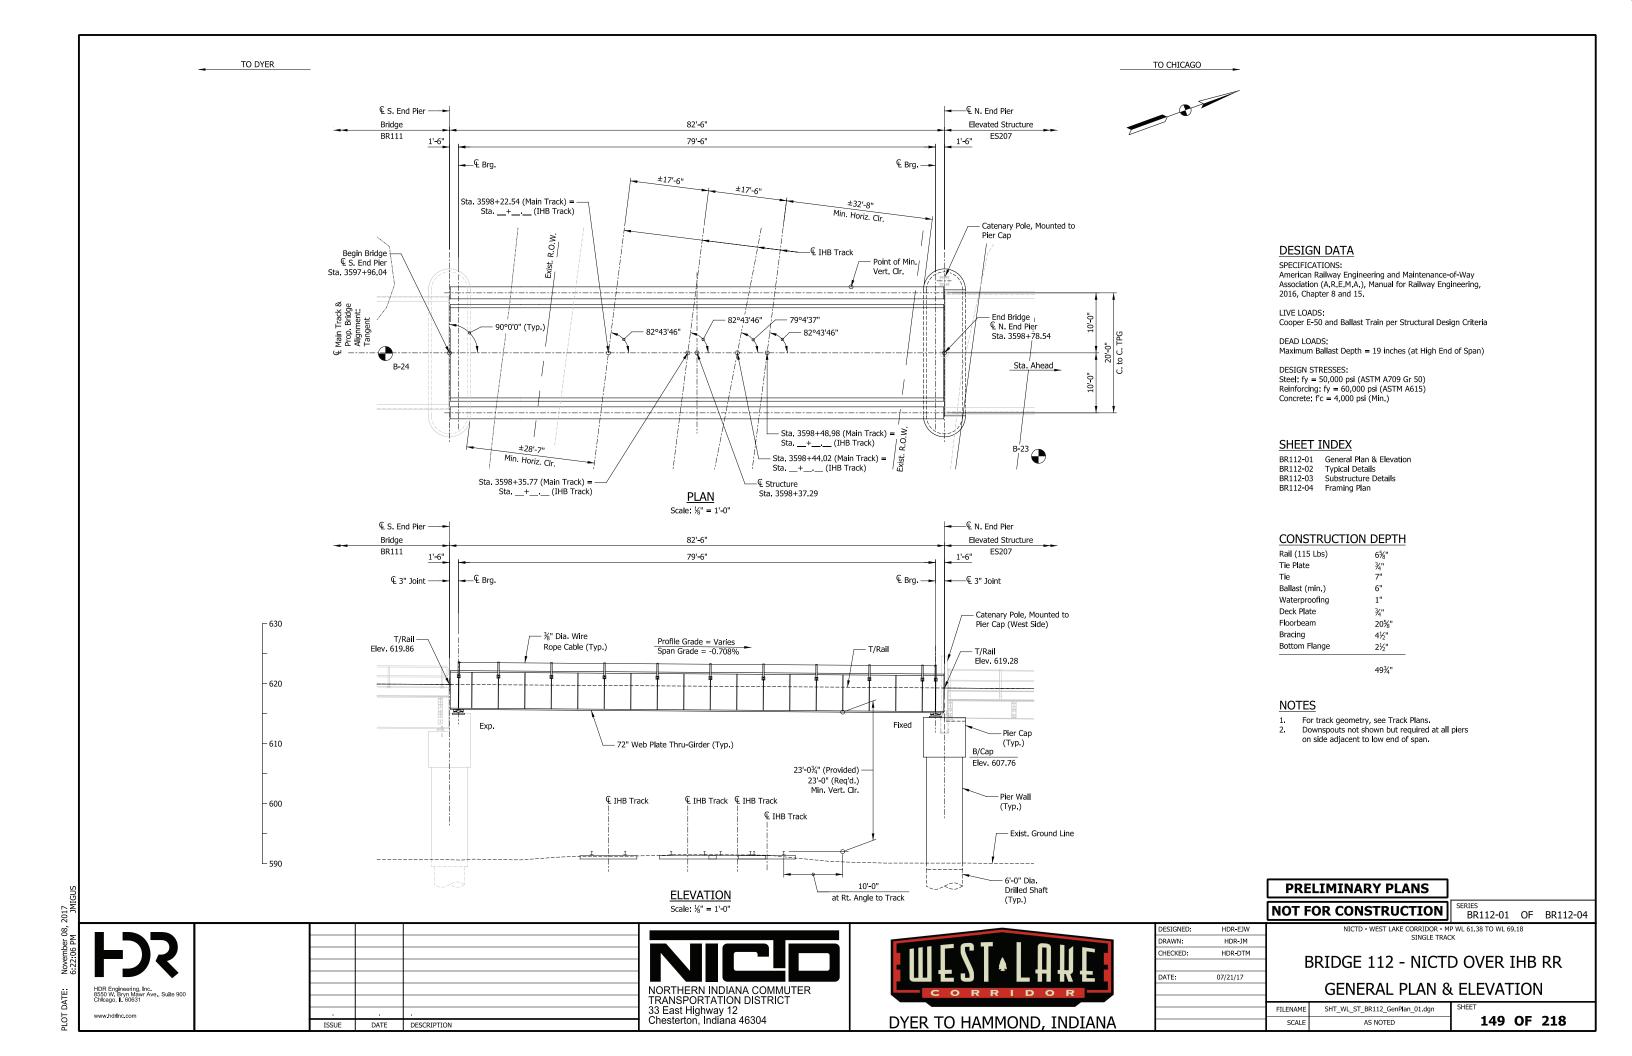

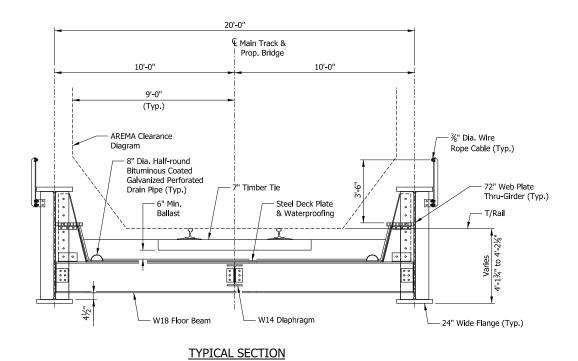

Scale: %" = 1'-0"

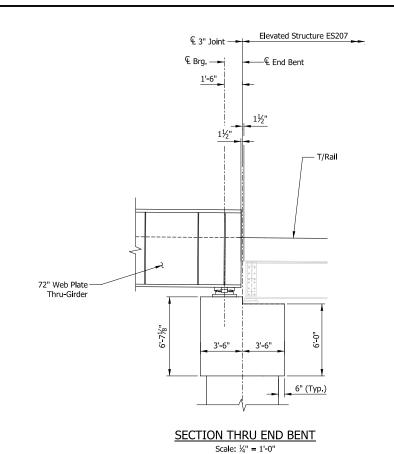

1,240.0' V.C. Main Track

> TOP OF RAIL PROFILE Not to Scale

DRAWN: HDR-JM CHECKED: HDR-DTM DATE: 07/21/17

NICTD - WEST LAKE CORRIDOR - MP WL 61.38 TO WL 69.18 SINGLE TRACK

BR112-02 OF BR112-04

150 OF 218

PRELIMINARY PLANS

NOT FOR CONSTRUCTION

BRIDGE 112 - NICTD OVER IHB RR TYPICAL DETAILS


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	FILENAME	SHT_WL_ST_BR112_TypDet_01.dgn	
DYER TO HAMMOND, INDIANA	SCALE	AS NOTED	



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ISSUE DATE DESCRIPTION

DYER TO HAMMOND, INDIANA

		NOT FOR CONSTRUCTION
DESIGNED:	HDR-EJW	NICTD - WEST LAKE CORRIDOR - MP N
DRAWN:	HDR-JM	SINGLE TRACK
CHECKED:	HDR-DTM	DDIDGE 113 NICTO
		BRIDGE 112 - NICTD
DATE:	07/21/17	SUBSTRUCTURE
		SUBSTRUCTURE

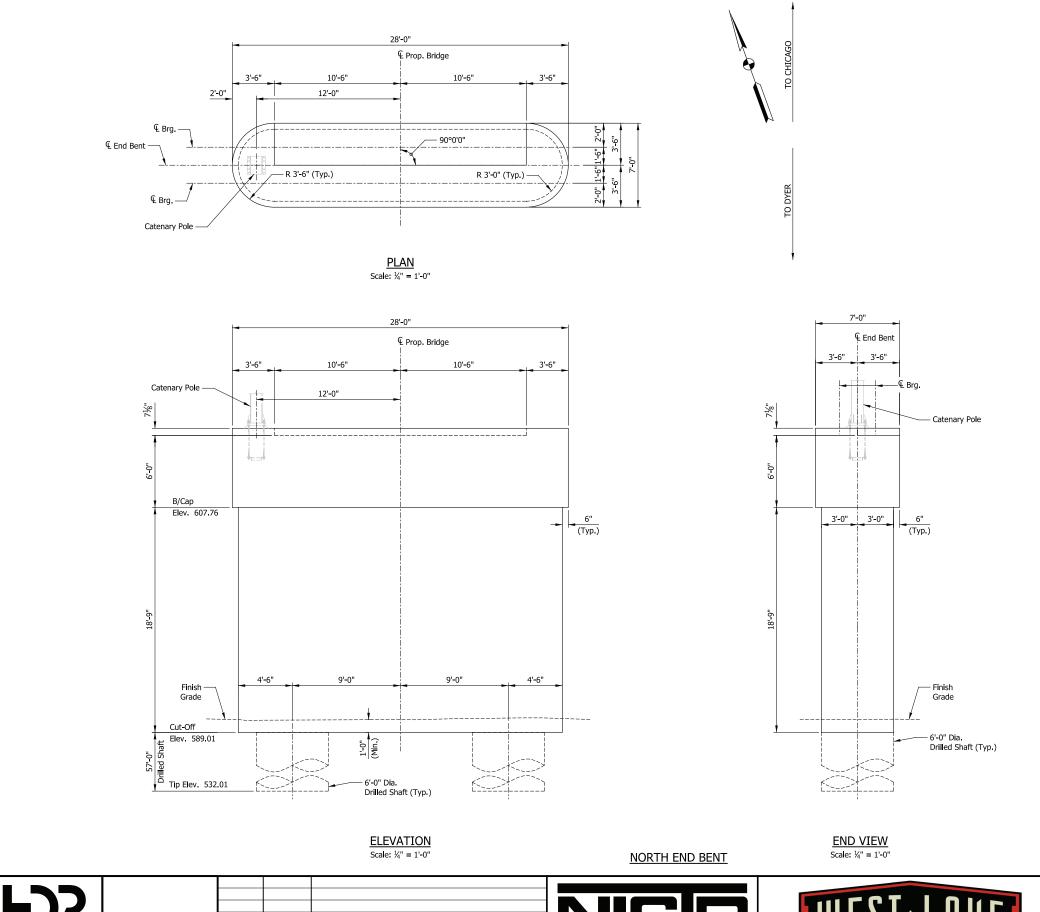
NICTD - WEST LAKE CORRIDOR - MP WL 61.38 TO WL 69.18 SINGLE TRACK
BRIDGE 112 - NICTD OVER IHB RR
SUBSTRUCTURE DETAILS

SERIES BR112-03 OF BR112-04

FILENAME SHT_WL_ST_BR112_SubstrDet_01.dgn

PRELIMINARY PLANS

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NORTHERN INDIANA COMMUTER TRANSPORTATION DISTRICT 33 East Highway 12 Chesterton, Indiana 46304

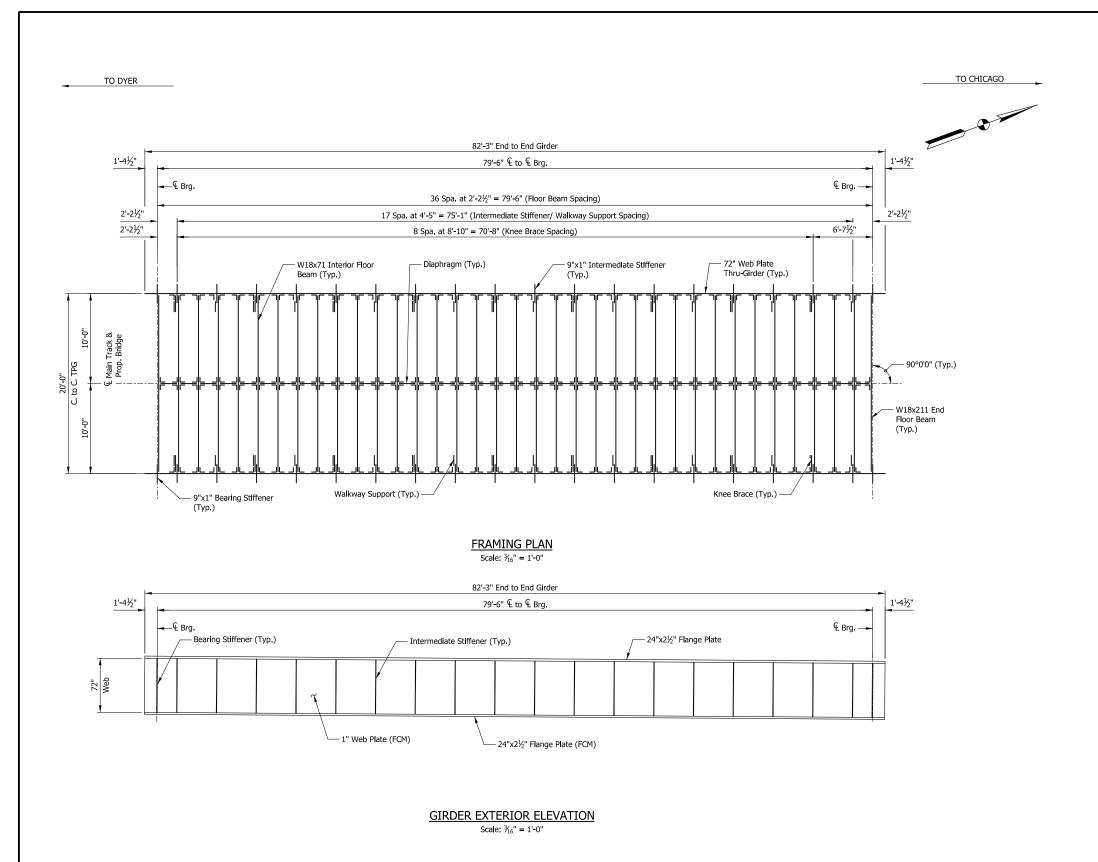

DESIGNED:	HDR-EJW
DRAWN:	HDR-JM
CHECKED:	HDR-DTM
DATE:	07/21/17

JW	NICTD - WEST LAKE CORRIDOR - MP WL 61.38 TO WL 69.18
JM	SINGLE TRACK
TM	DDIDGE 113 NIGTO OVED TUD DD
	BRIDGE 112 - NICTD OVER IHB RR
7	


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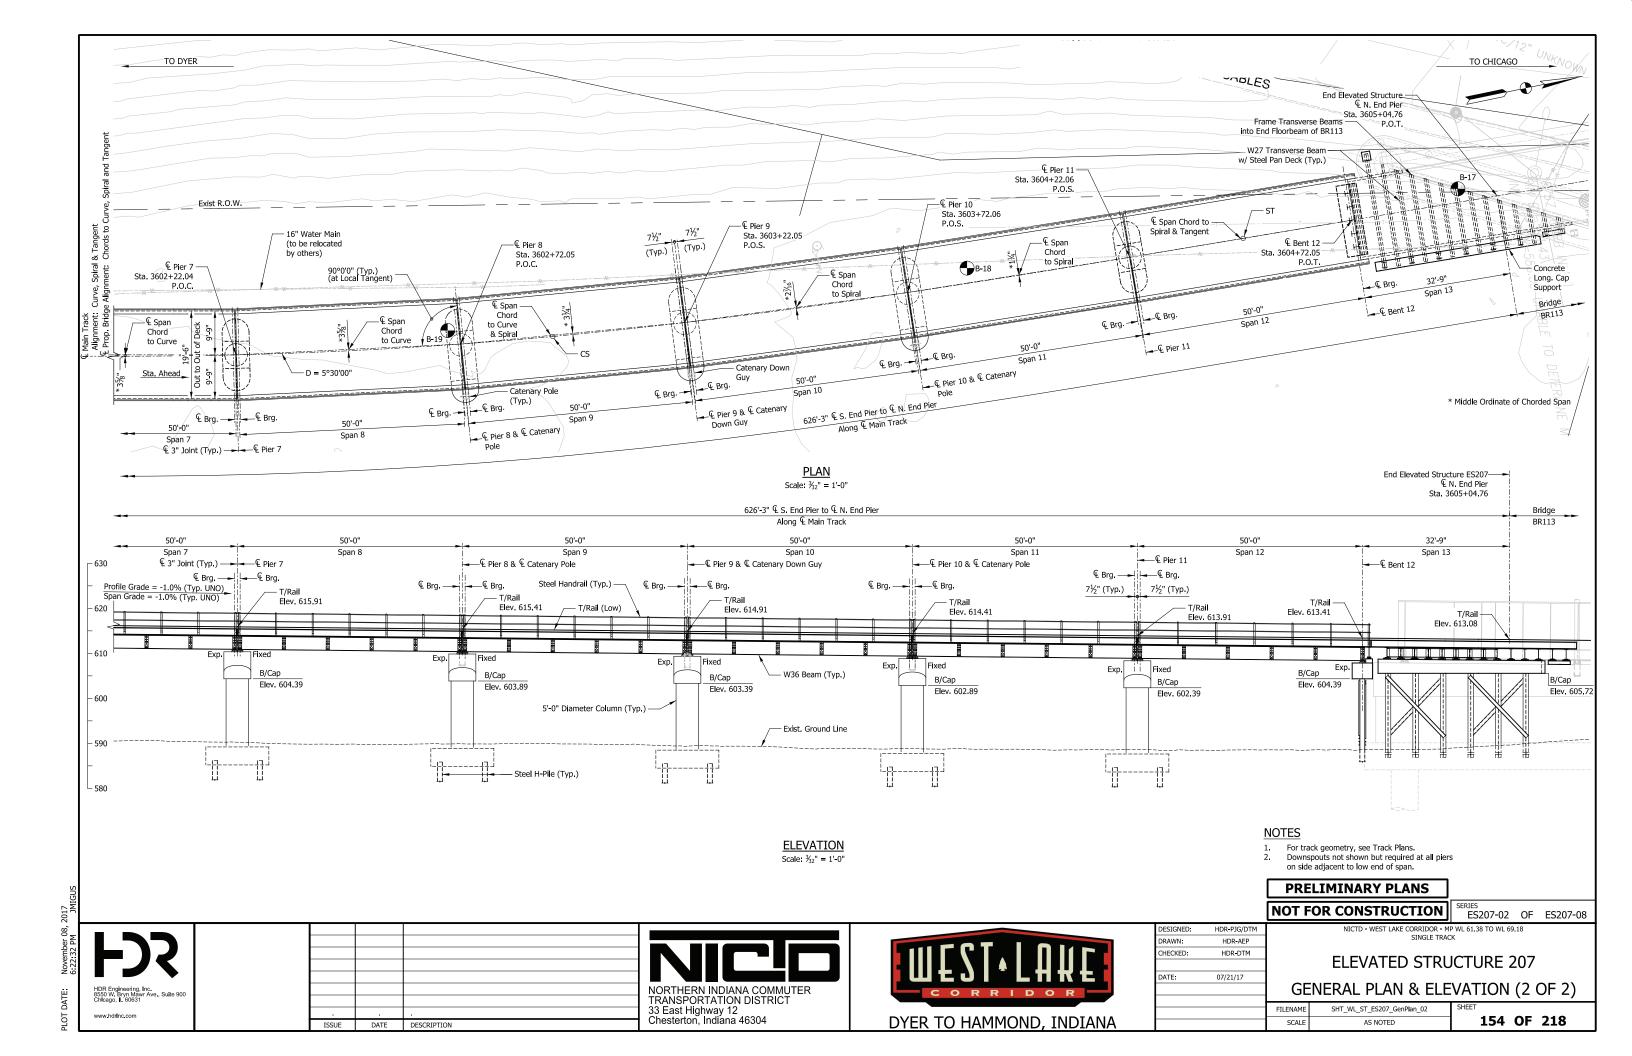
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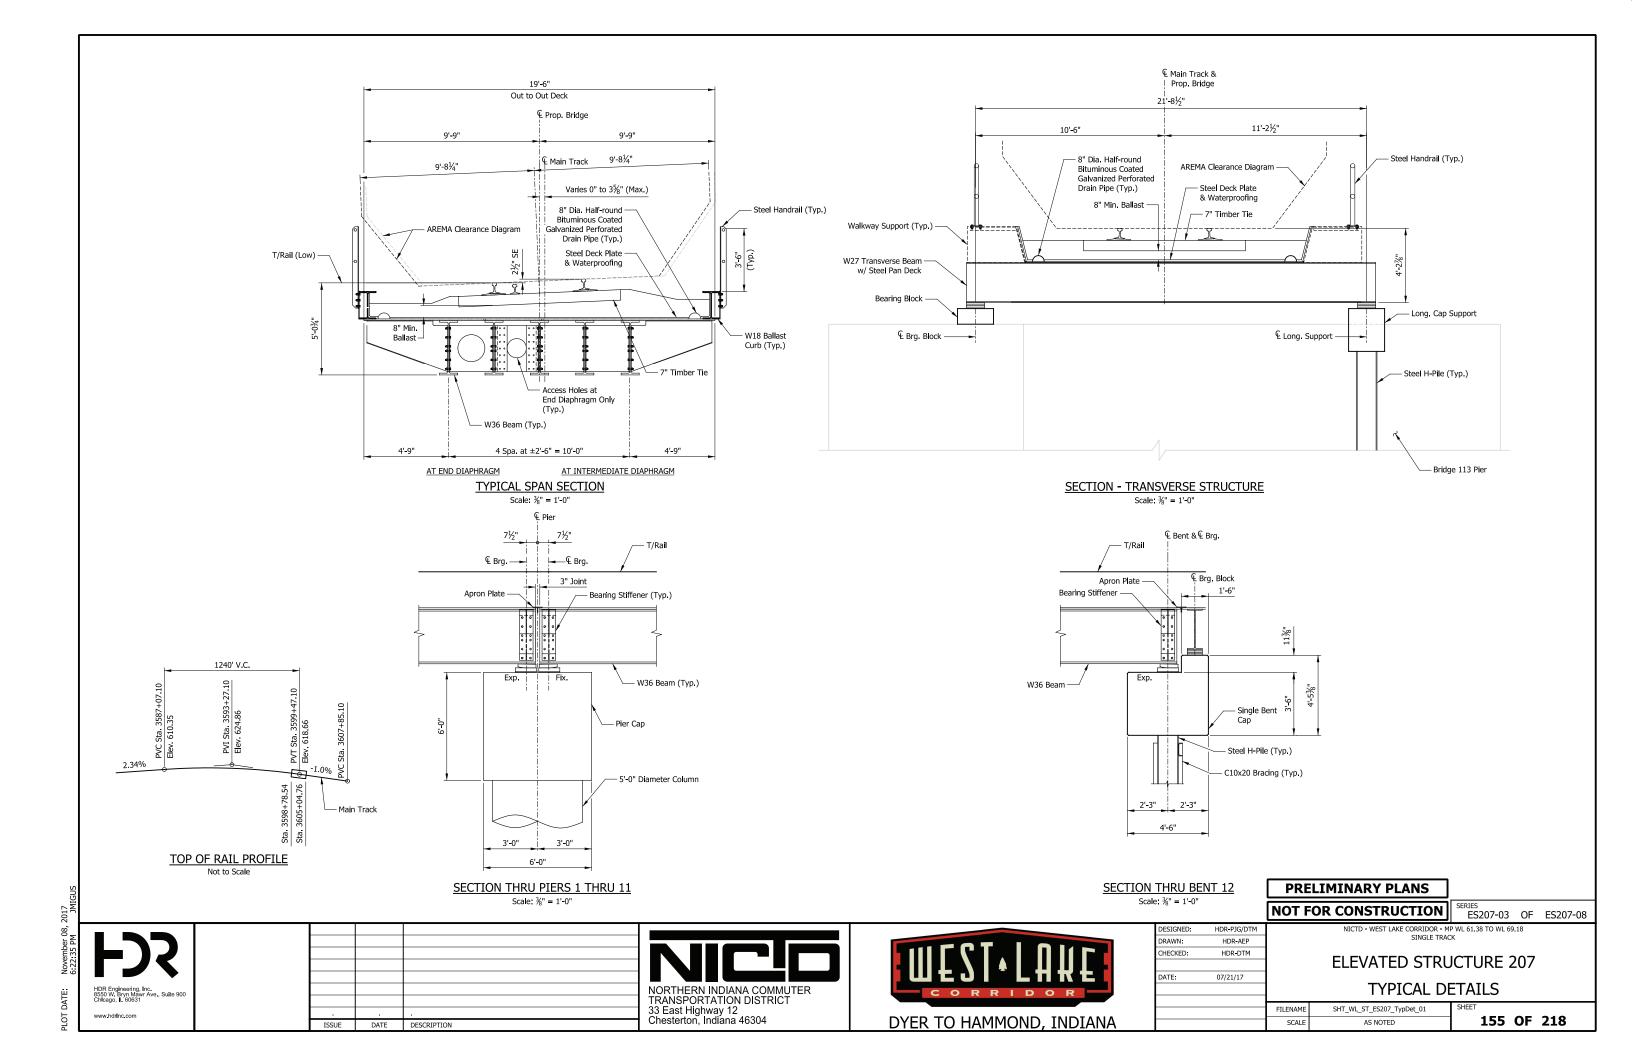
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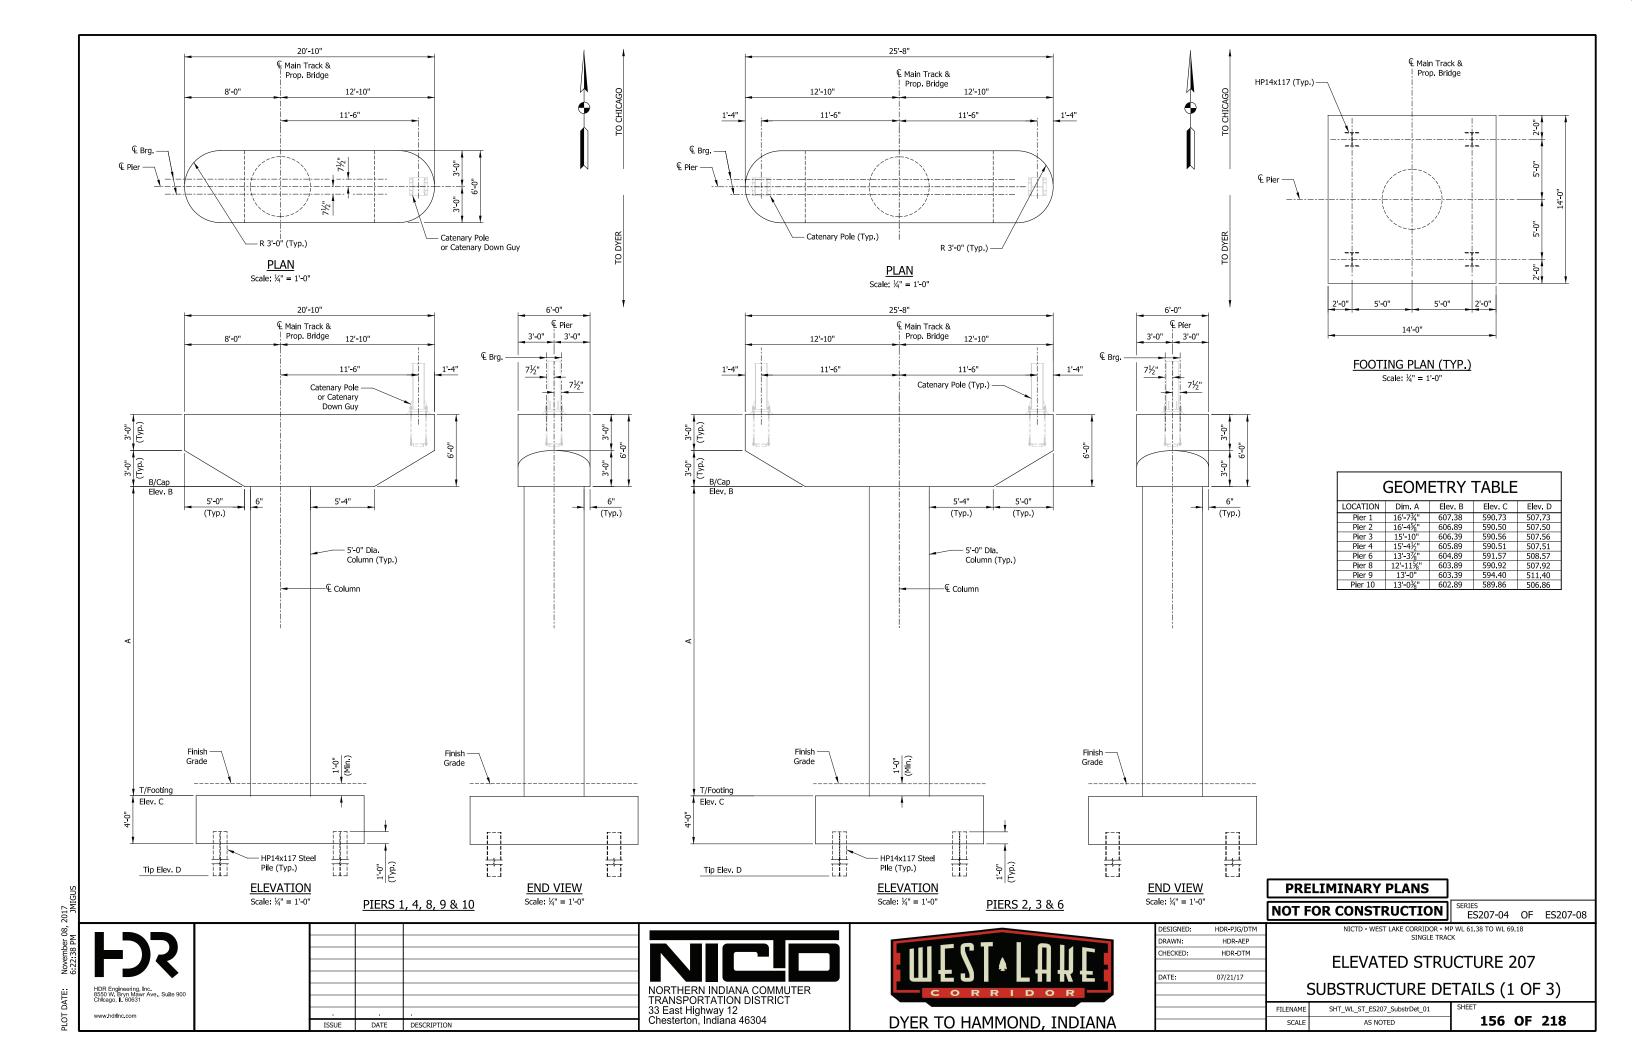
SERIES BR112-04 OF BR112-04


FILENAME SHT_WL_ST_BR112_FramPlan_01.dgn 152 OF 218 AS NOTED








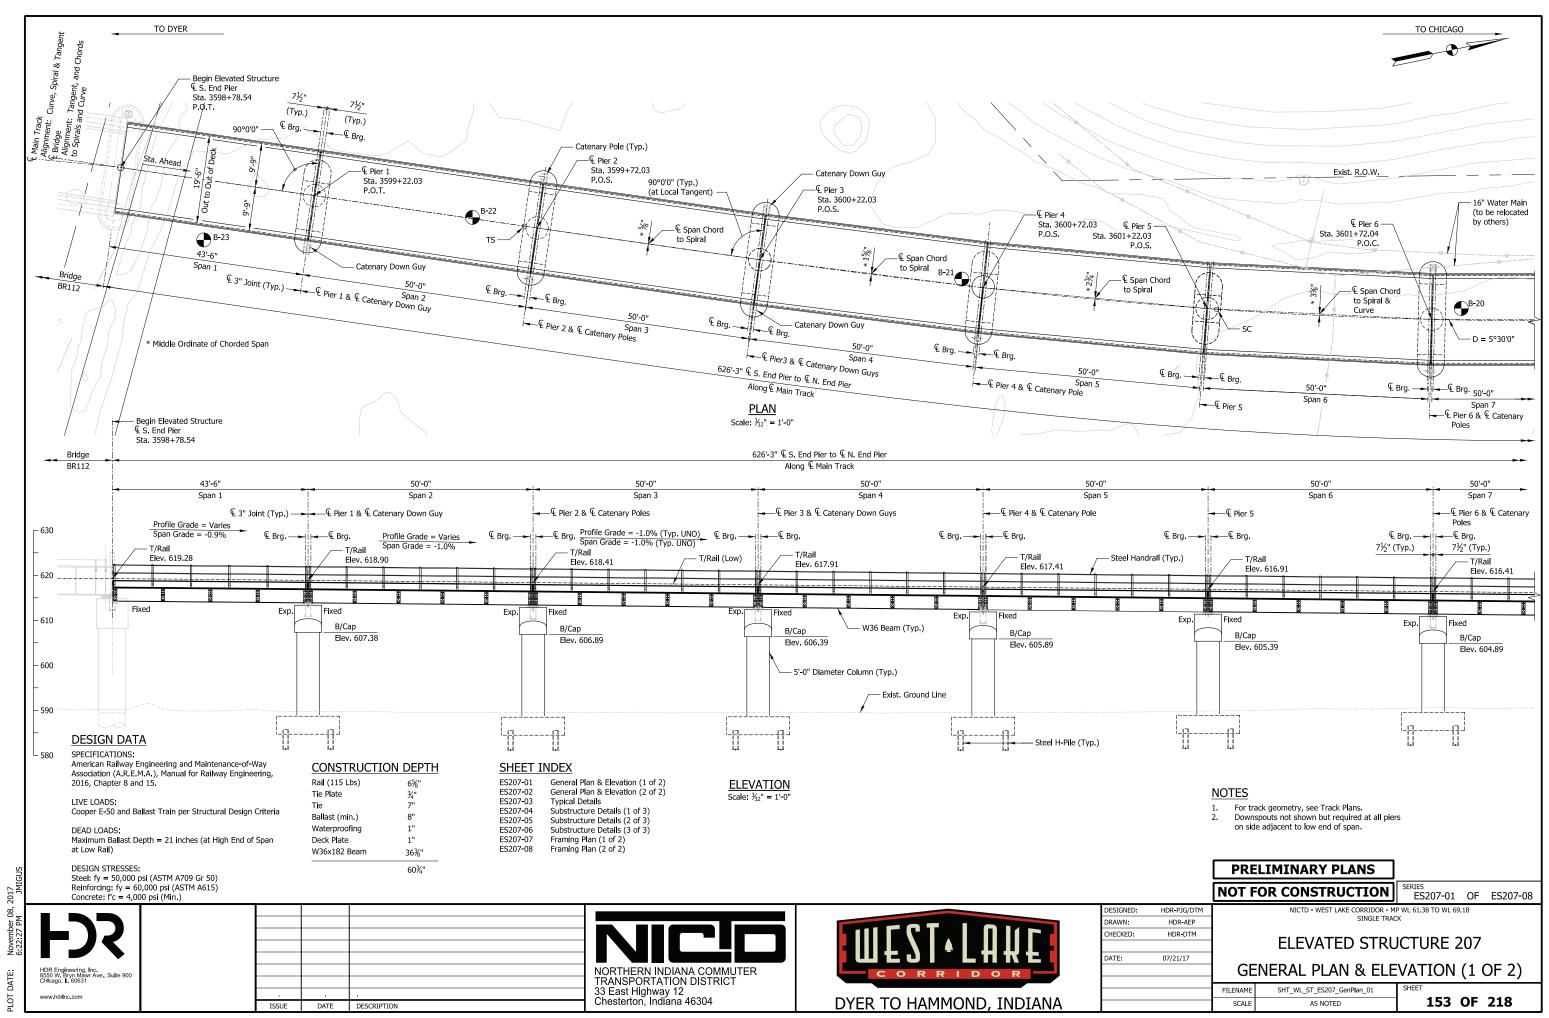

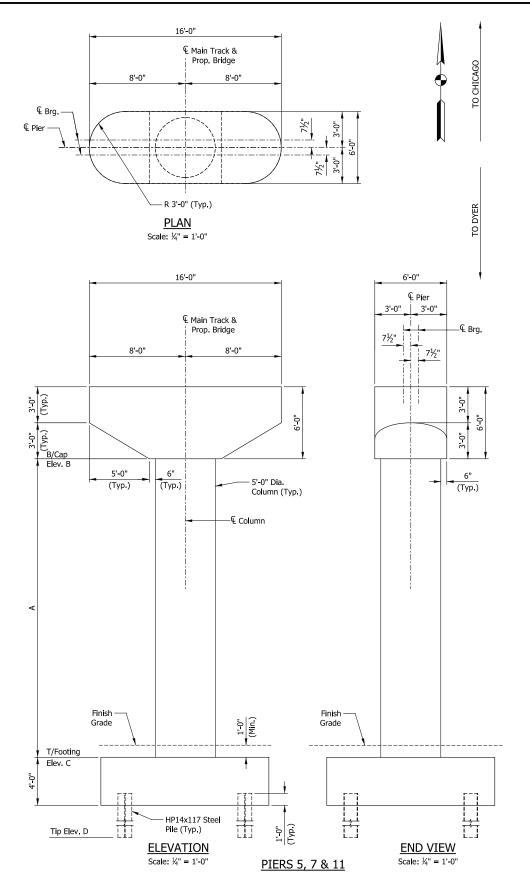

DATE DESCRIPTION

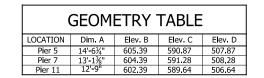

PRELIMINARY PLANS

NOT FOR CONSTRUCTION


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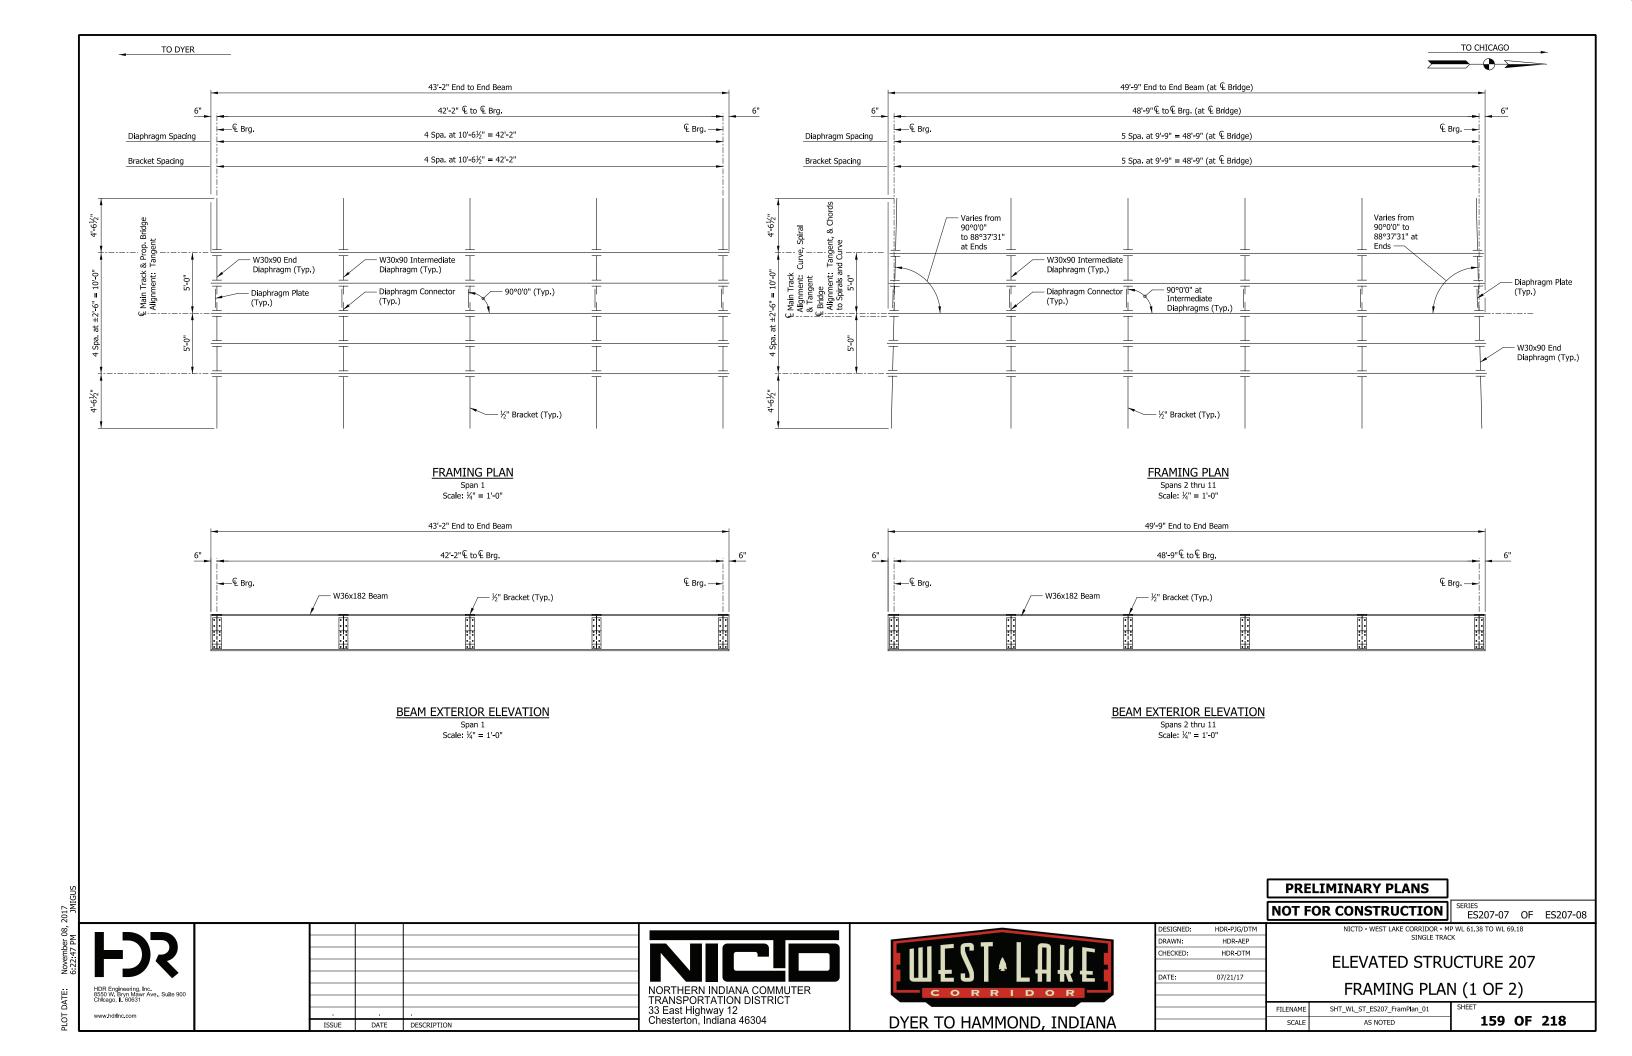
SERIES ES207-05 OF ES207-08


NICTD - WEST LAKE CORRIDOR - MP WL 61.38 TO WL 69.18 SINGLE TRACK

DYER TO HAMMOND, INDIANA

NORTHERN INDIANA COMMUTER TRANSPORTATION DISTRICT
33 East Highway 12 Chesterton, Indiana 46304



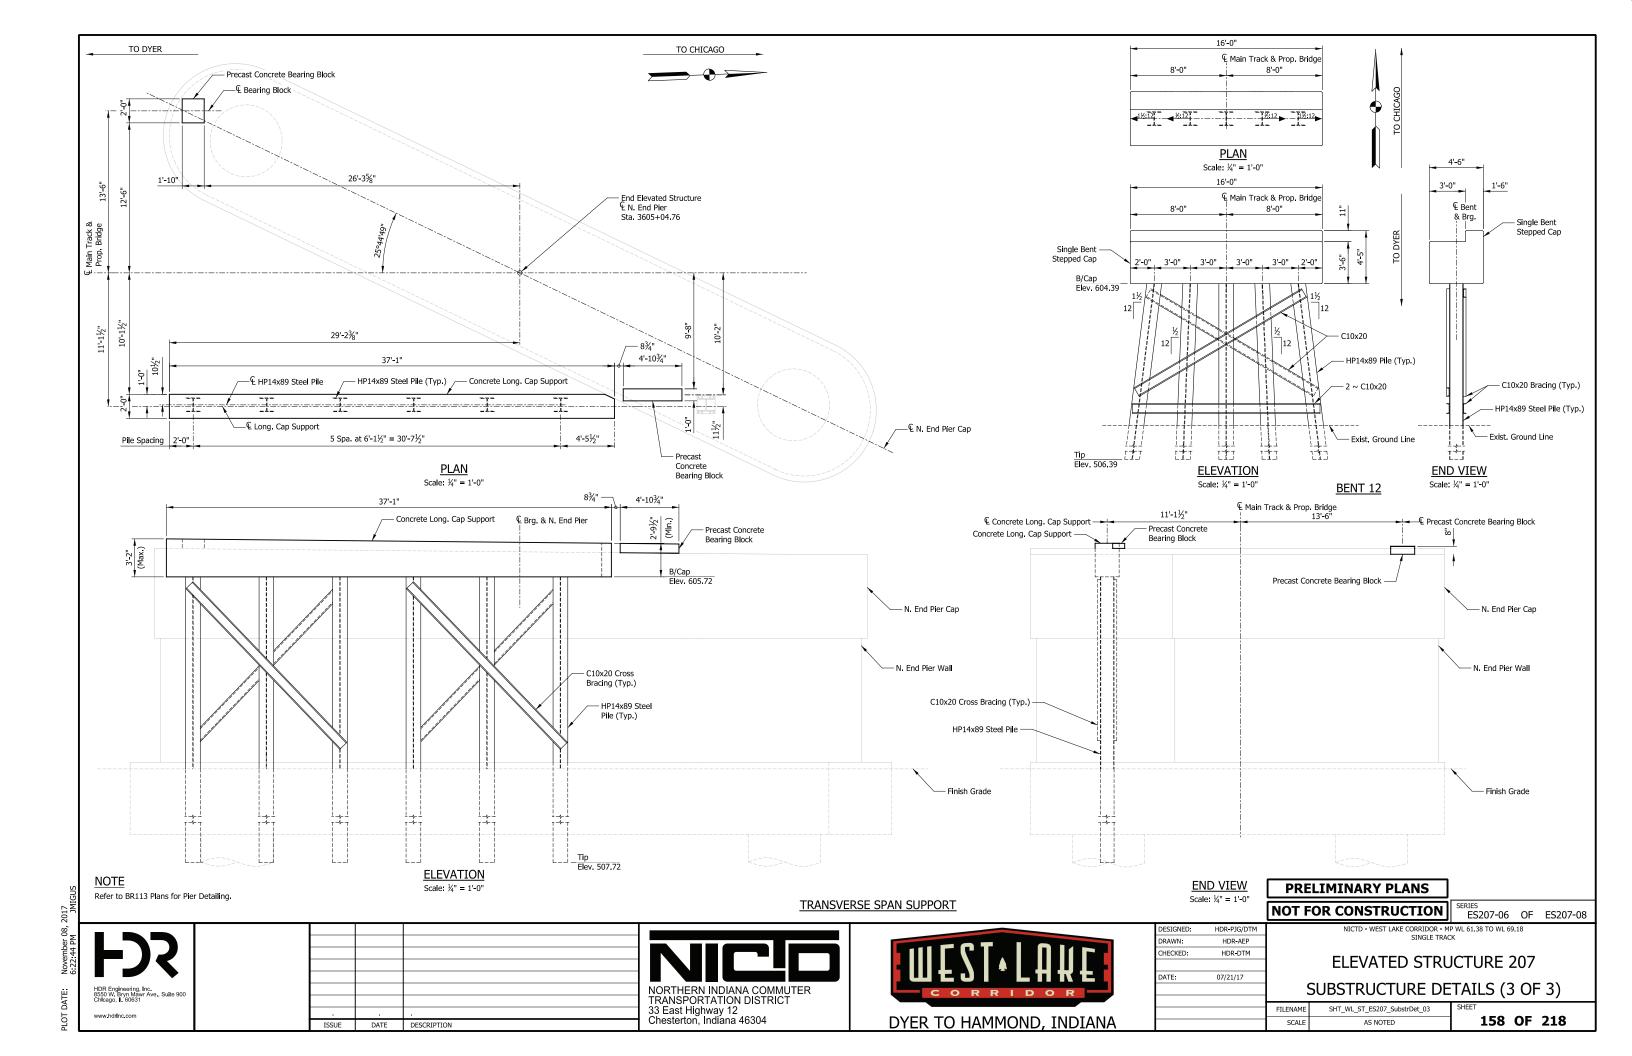

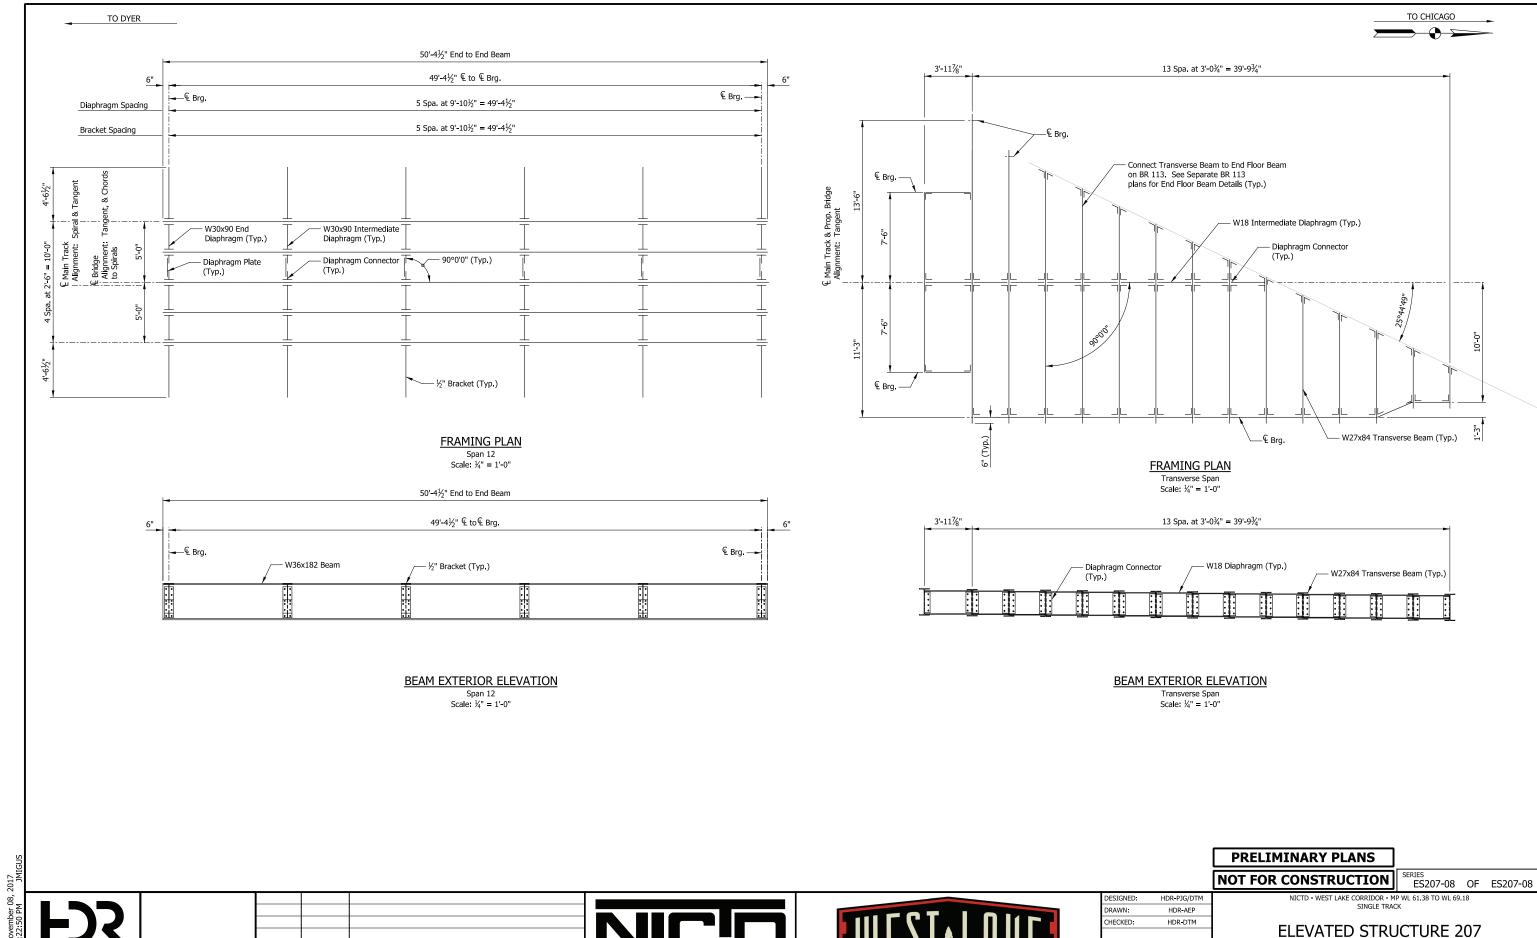

NORTHERN INDIANA COMMUTER TRANSPORTATION DISTRICT 33 East Highway 12 Chesterton, Indiana 46304

DATE:

DYER TO HAMMOND, INDIANA

07/21/17

FILENAME

FRAMING PLAN (2 OF 2)


160 OF 218


SHT_WL_ST_ES207_FramPlan_02

AS NOTED


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DATE DESCRIPTION



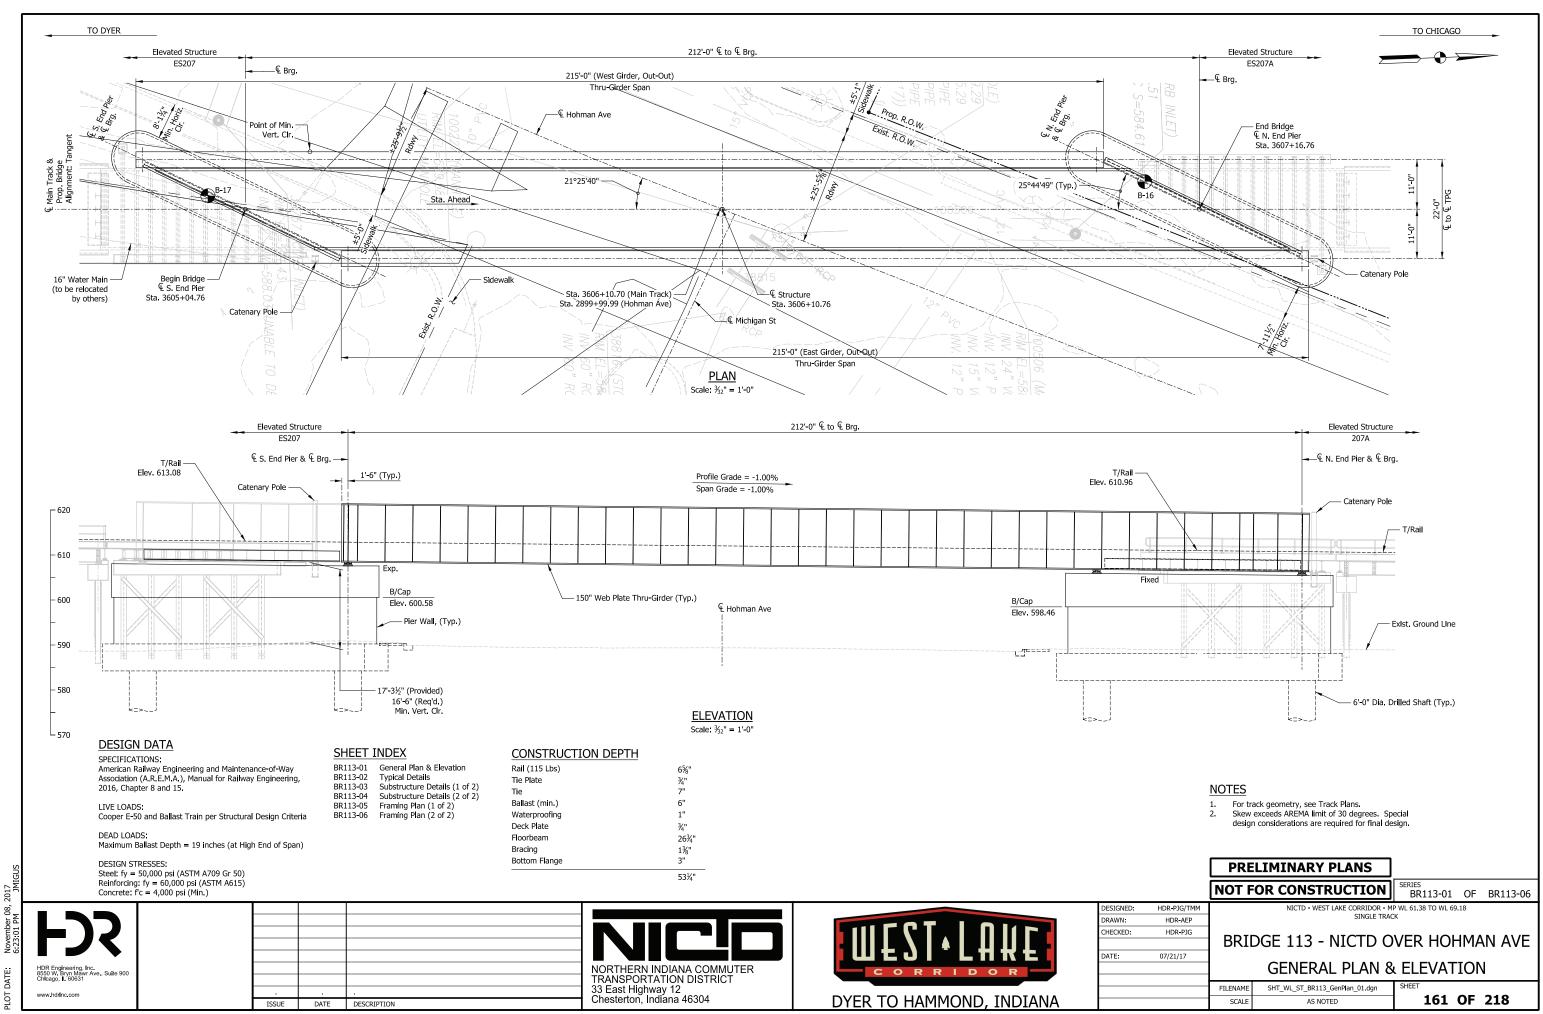


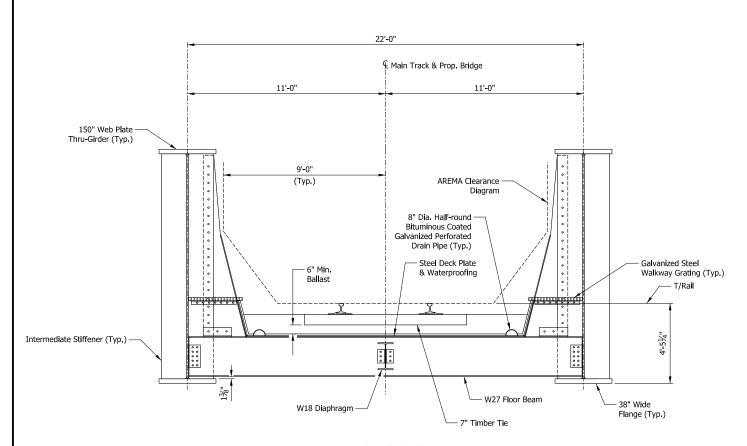TYPICAL SECTION Scale: 3/8" = 1'-0"

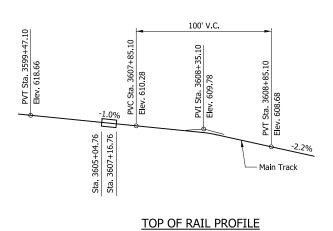

DATE DESCRIPTION

Not to Scale

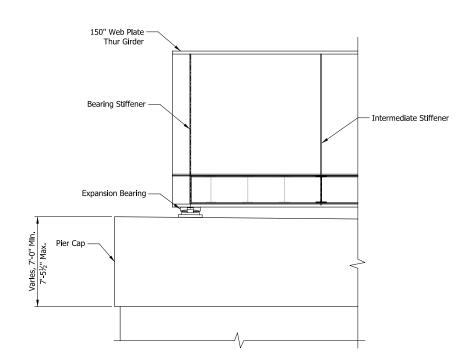

SECTION THRU S. END PIER N. End Pier Similar Scale: 1/4" = 1'-0"

DESIGNED:

DRAWN: HECKED:

DATE:

HDR-PJG/TMM

HDR-AEP

HDR-PJG

FILENAME

07/21/17

PRELIMINARY PLANS

AS NOTED

NOT FOR CONSTRUCTION

SERIES BR113-02 OF BR113-06

162 OF 218

NICTD - WEST LAKE CORRIDOR - MP WL 61.38 TO WL 69.18 SINGLE TRACK

BRIDGE 113 - NICTD OVER HOHMAN AVE


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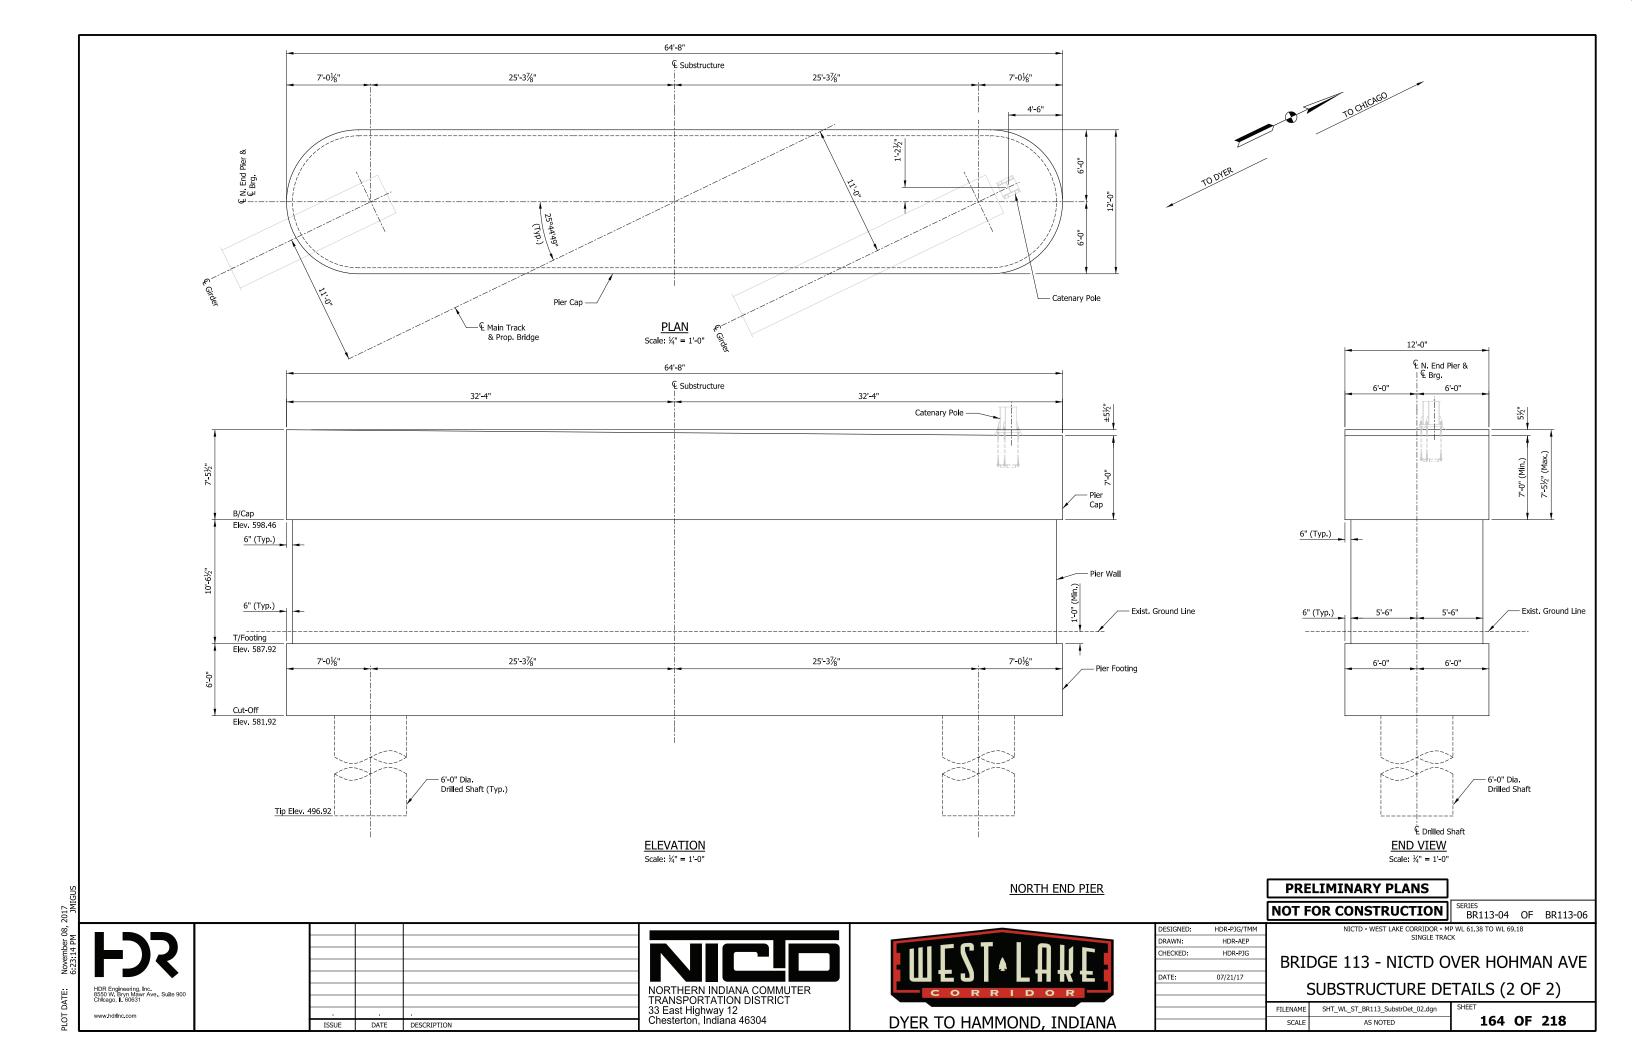
NORTHERN INDIANA COMMUTER TRANSPORTATION DISTRICT 33 East Highway 12 Chesterton, Indiana 46304




WEST.
DYER TO HAMMO


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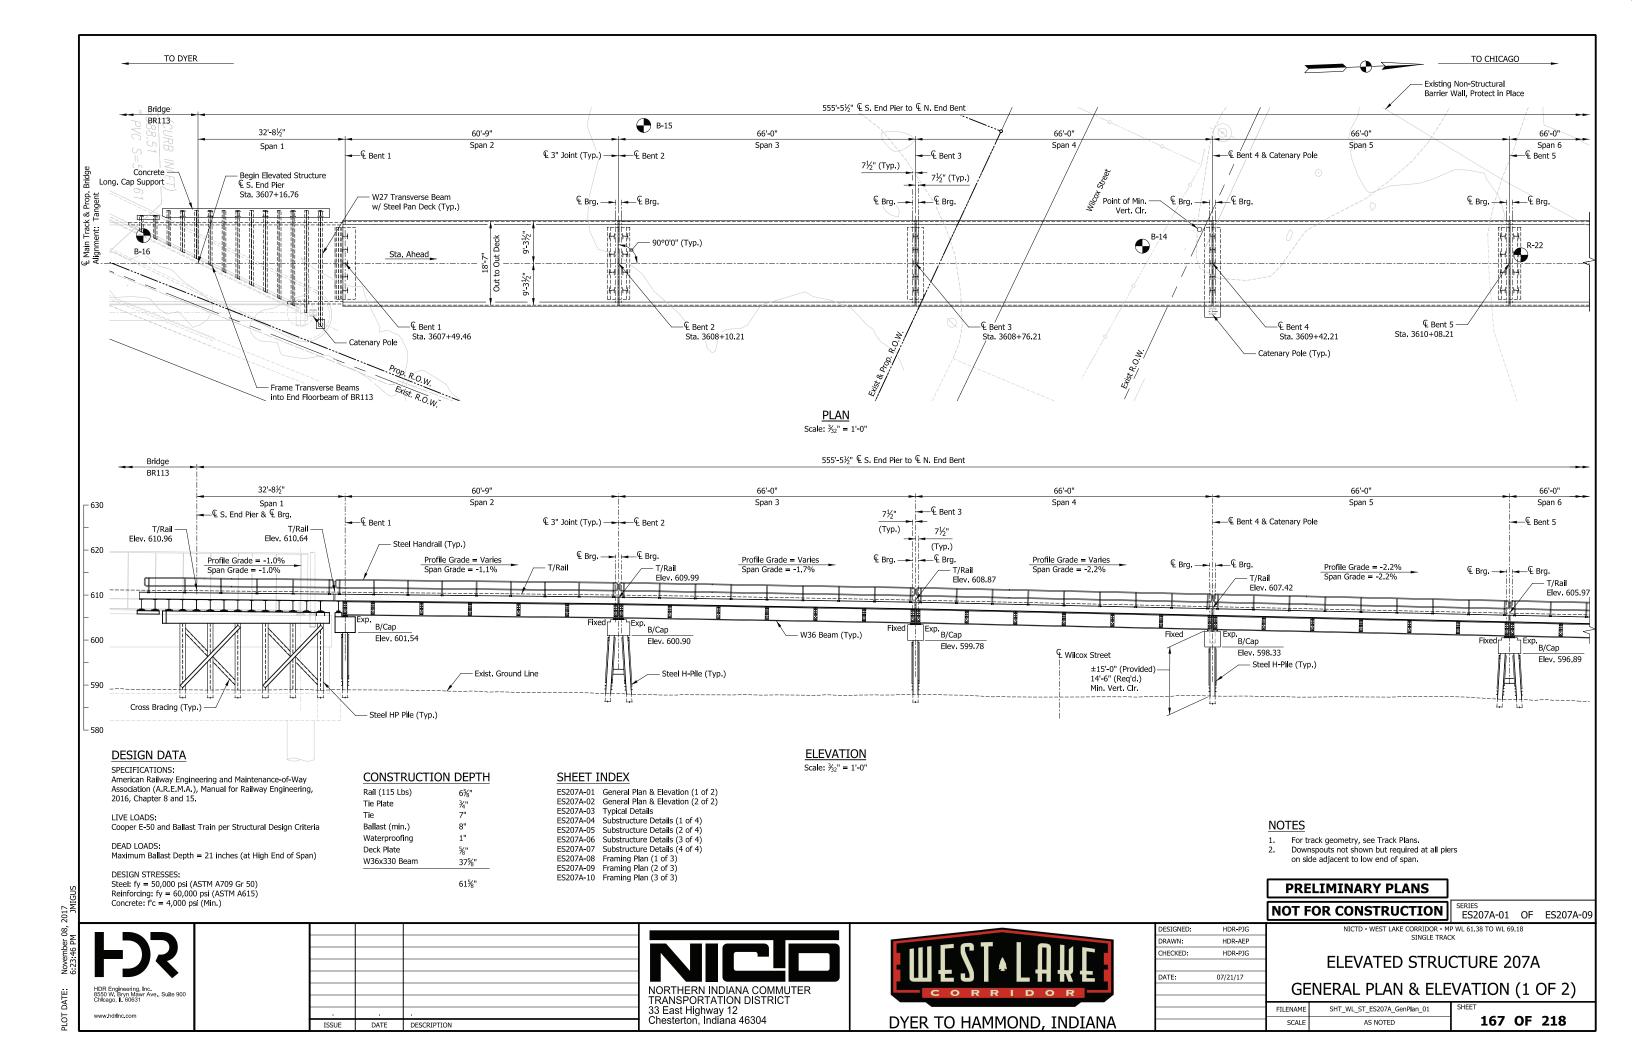


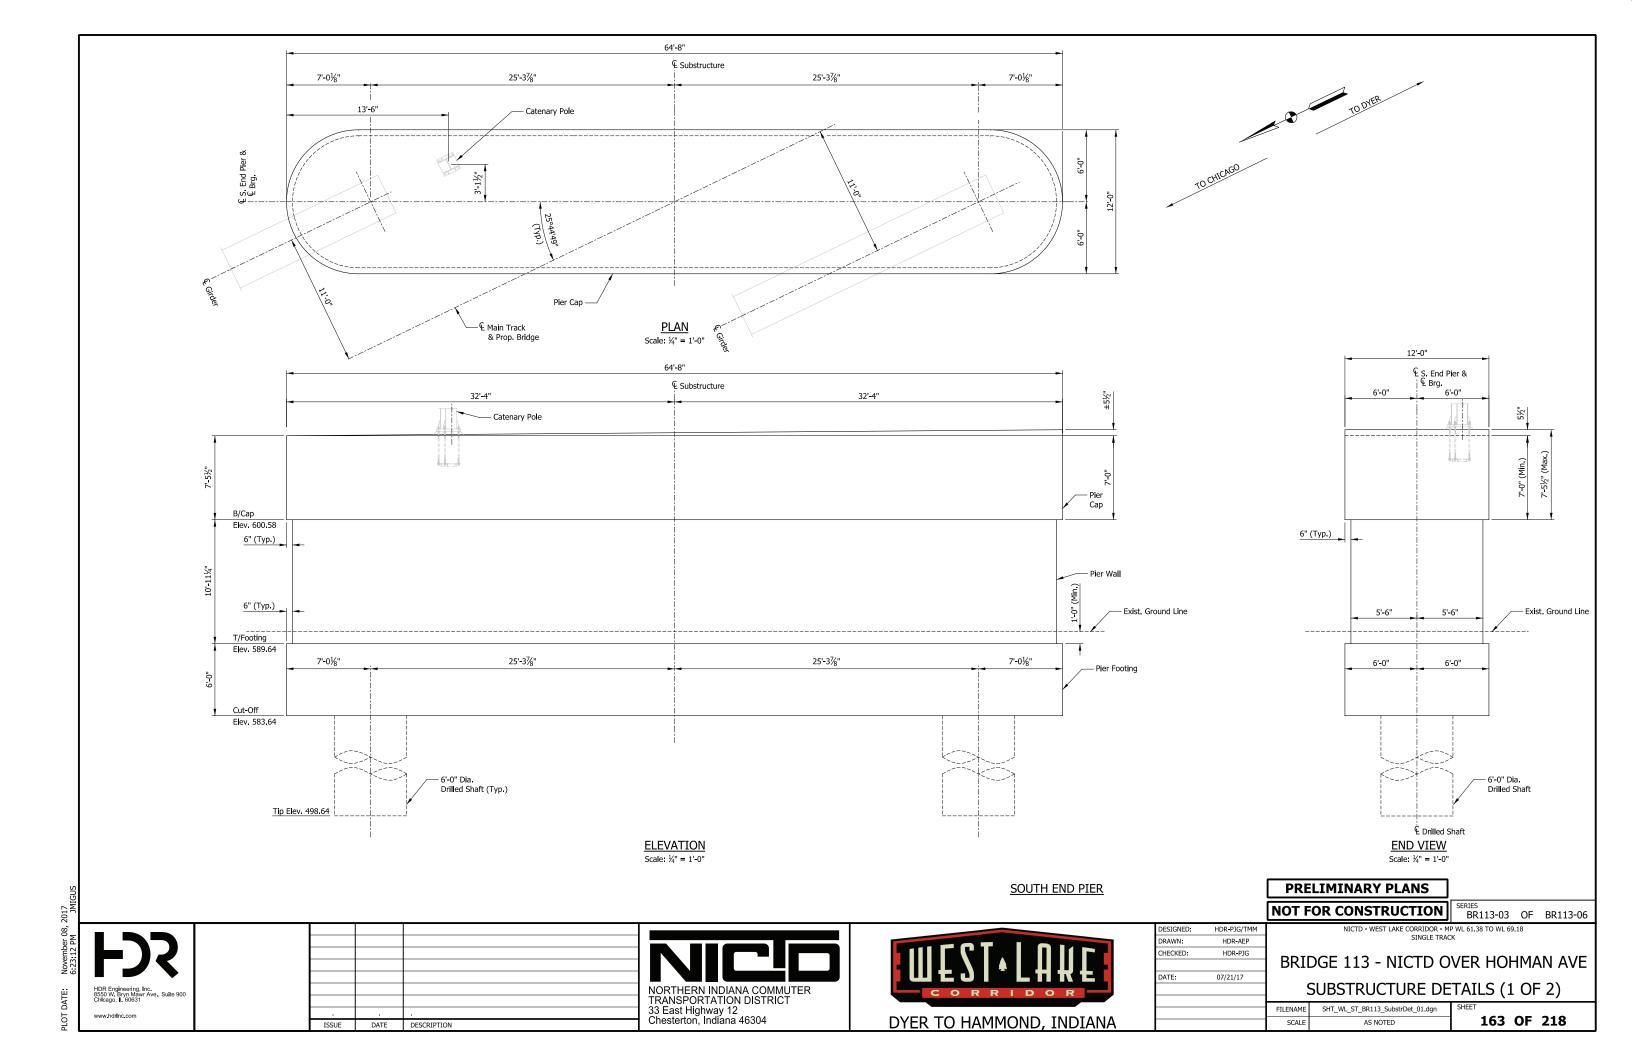



ATE: November 08, 2017

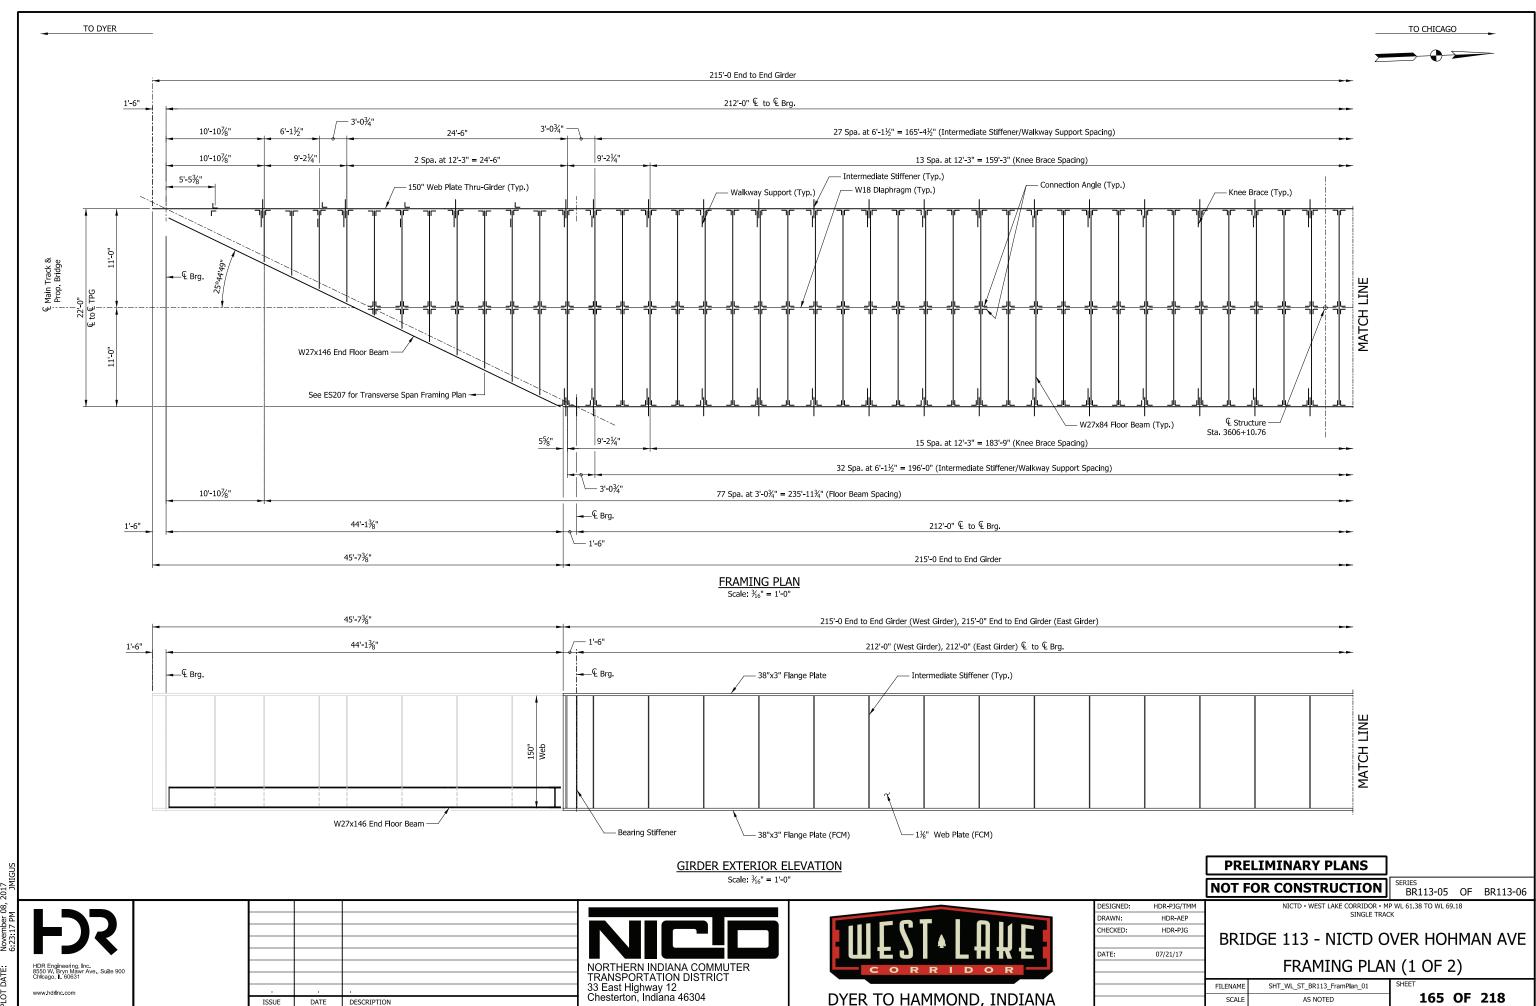



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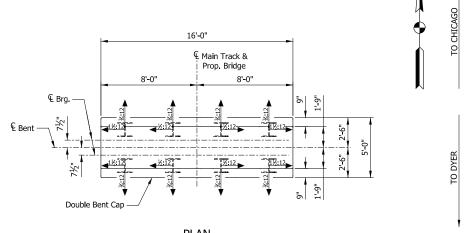
16'-0"

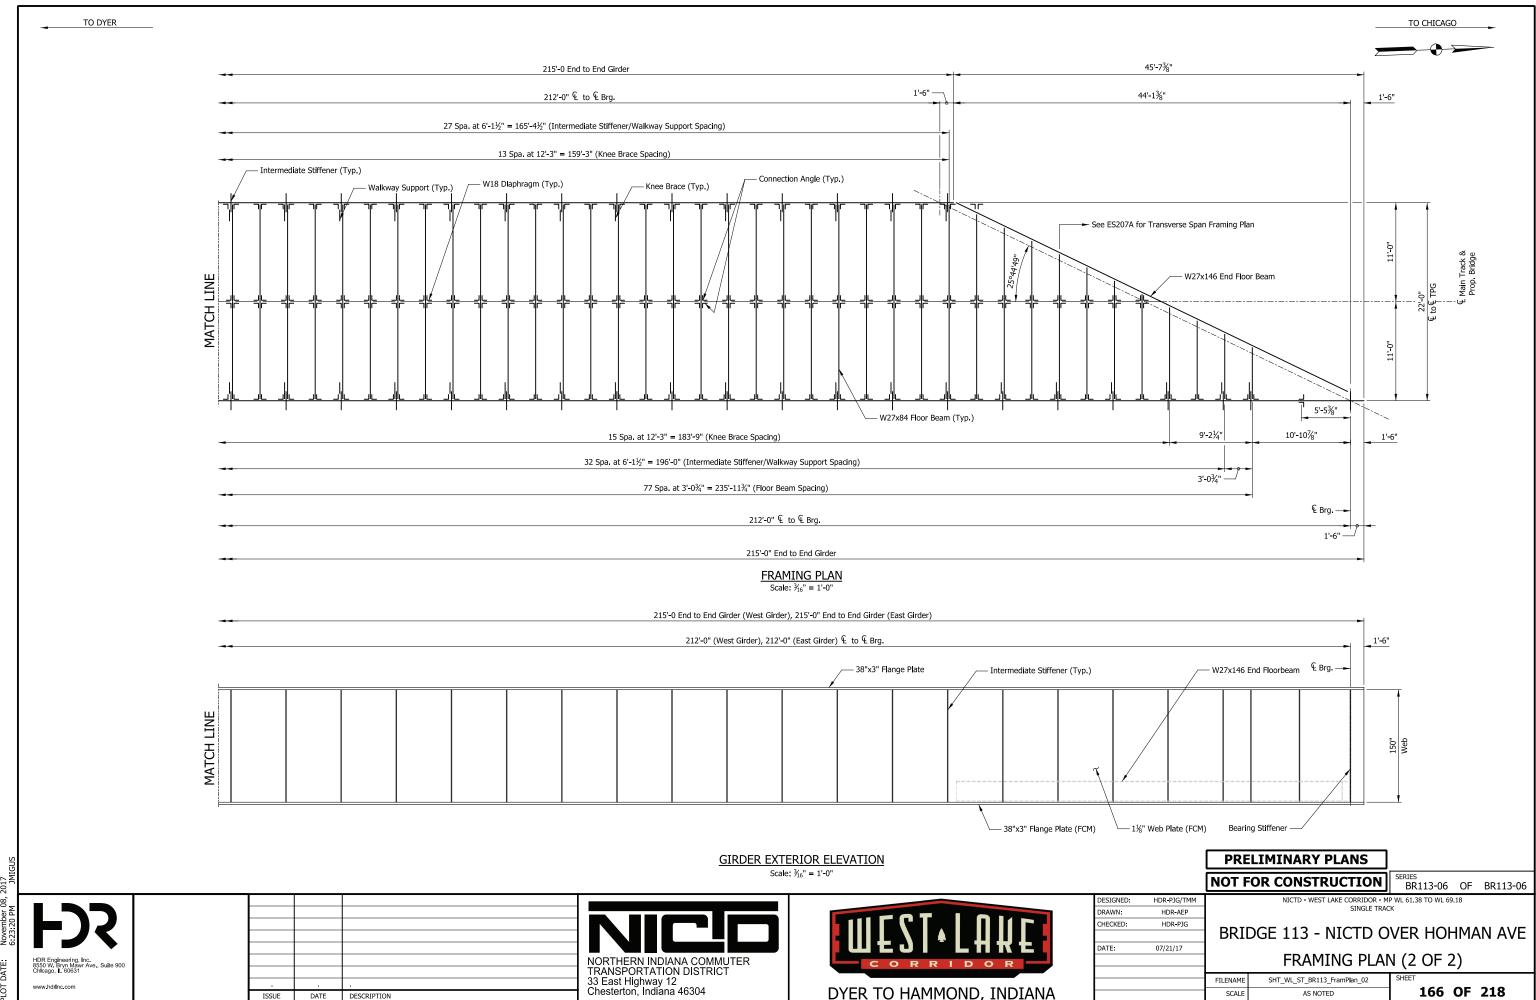
ELEVATION
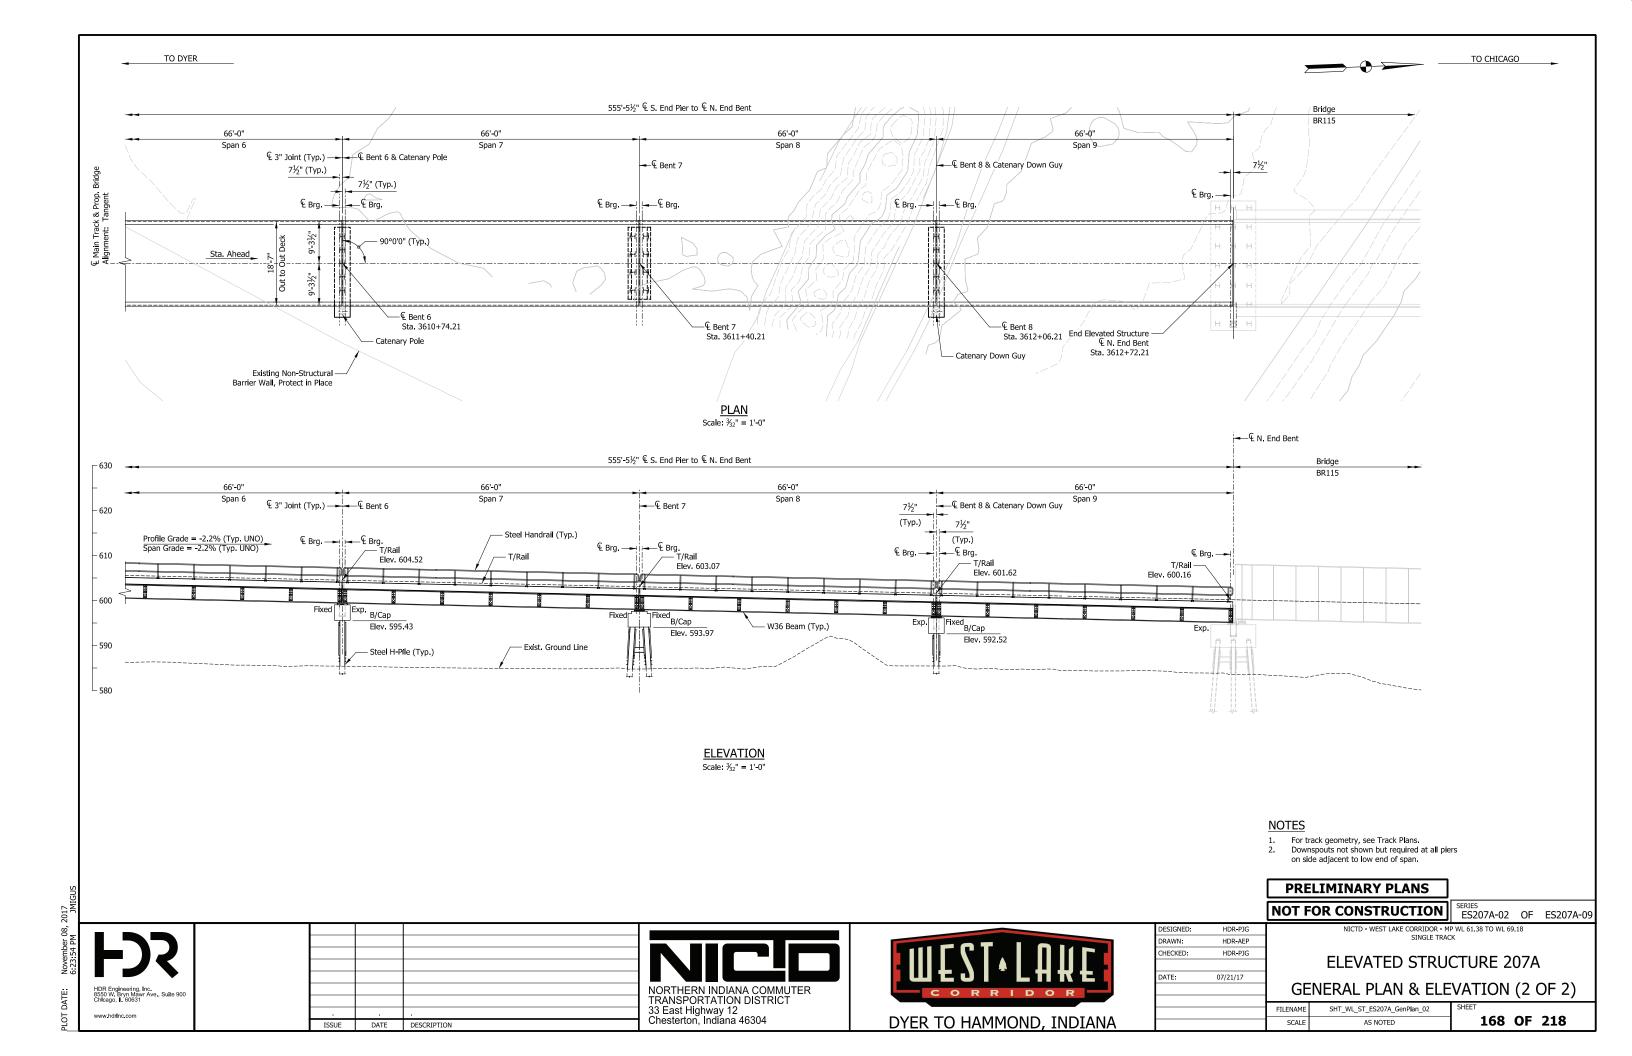
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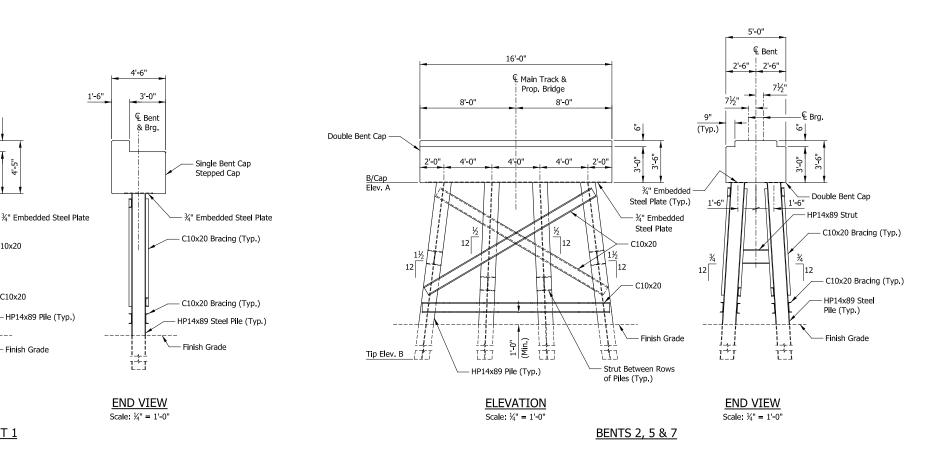
€ Main Track &

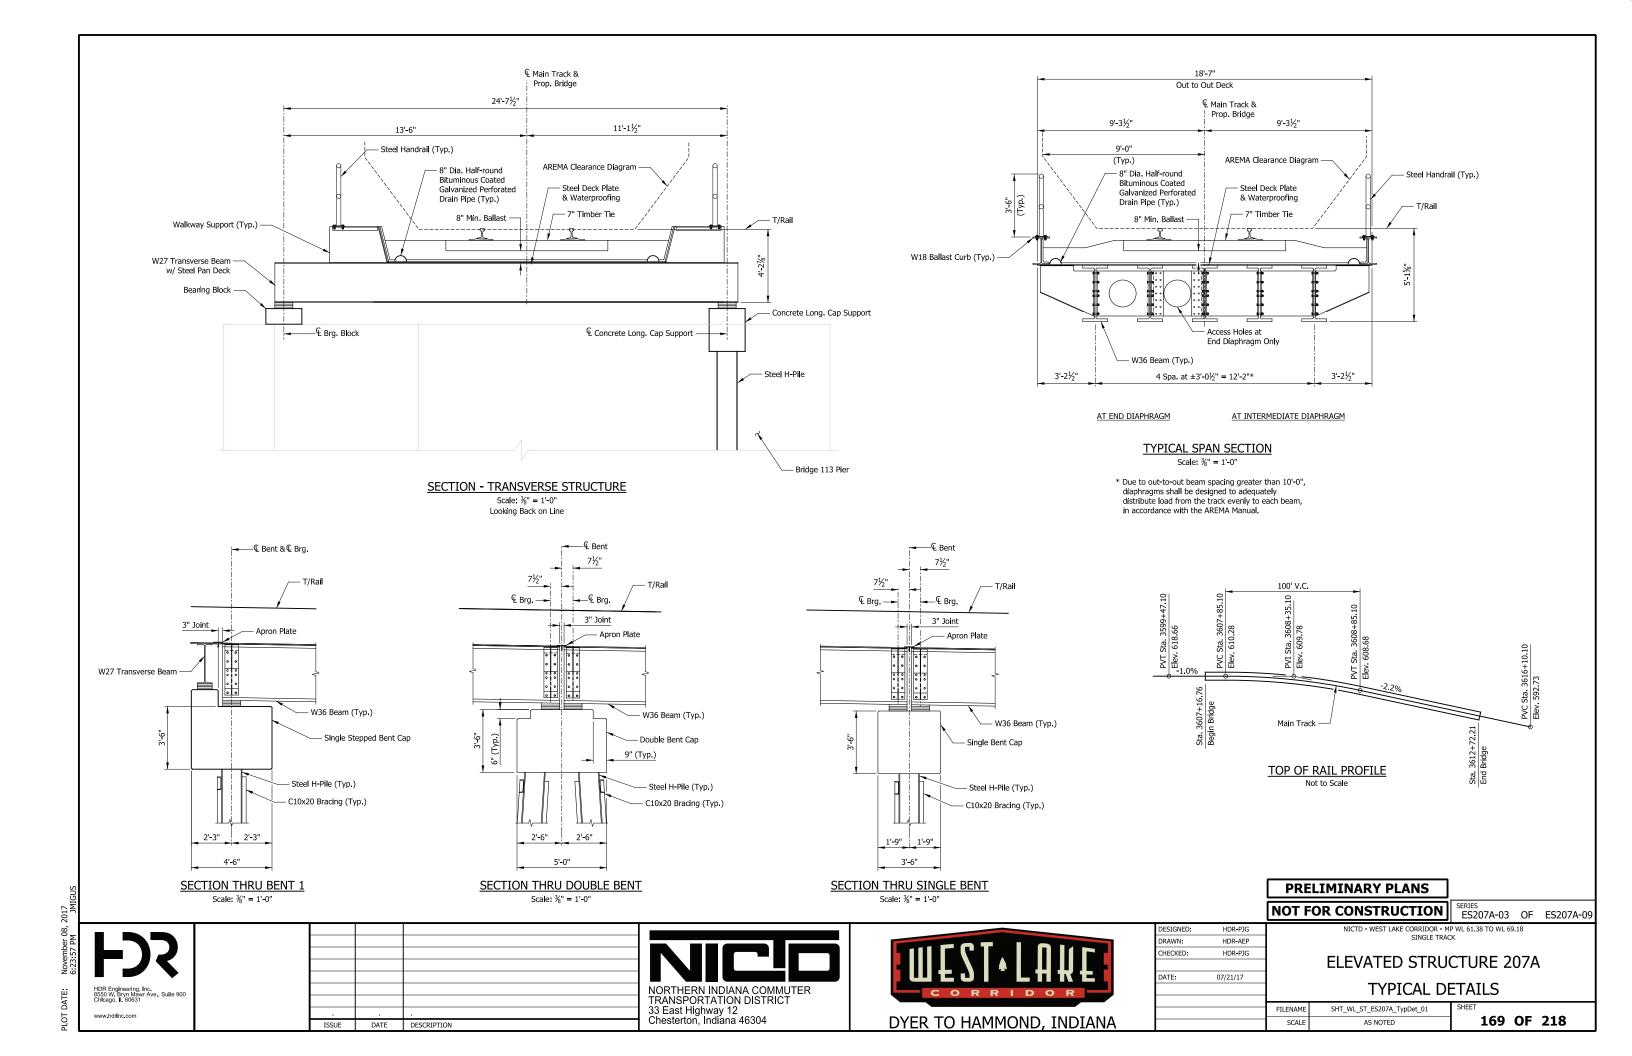Prop. Bridge

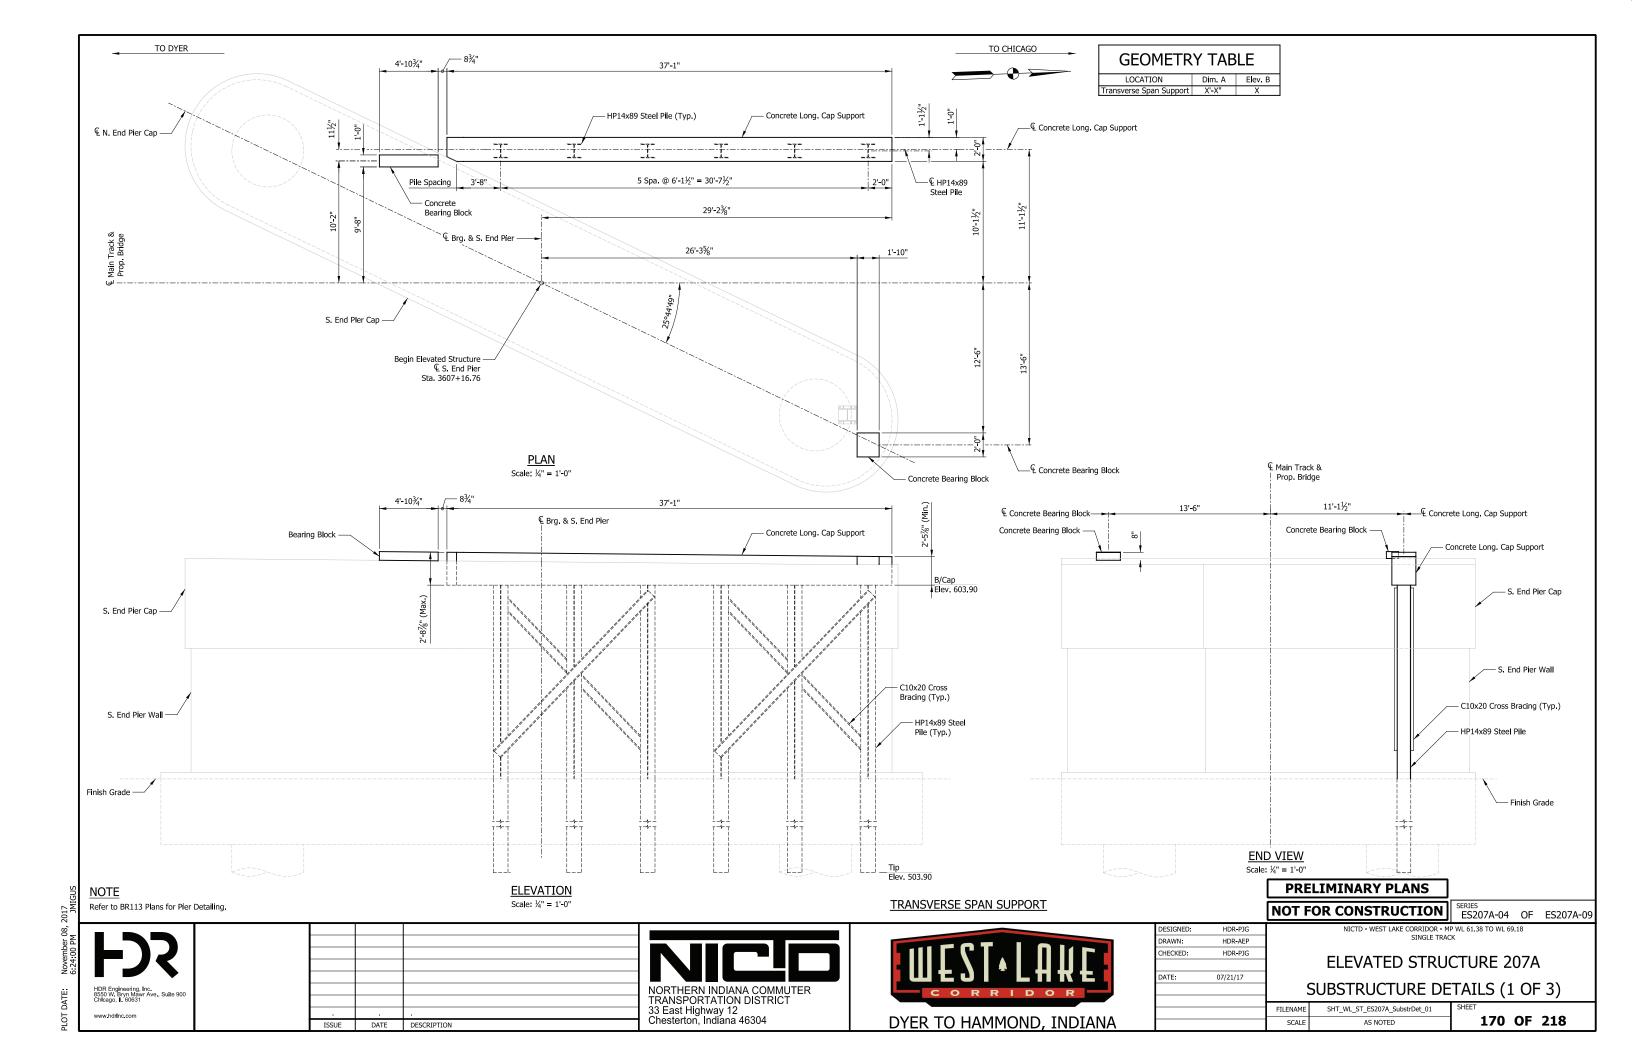

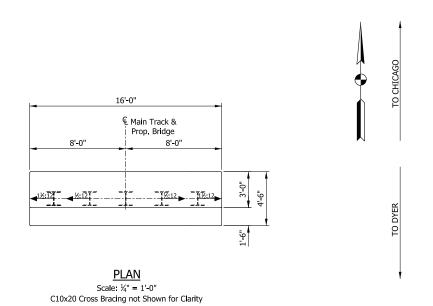

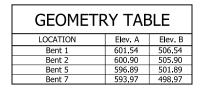PLAN Scale: 1/4" = 1'-0" HP14x89 Struts and C10x20 Cross Bracing Not Shown for Clarity






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Single Bent Cap Stepped Cap

Tip Elev. B

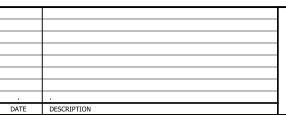

- C10x20

Finish Grade

BENT 1






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	NICTD - WEST LAKE CORRIDOR - M		HDR-PJG	SIGNED:
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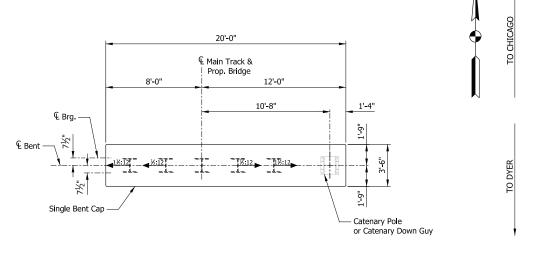
PRELIMINARY PLANS


OR - MP WL 61.38 TO WL 69.18 LE TRACK RUCTURE 207A DETAILS (2 OF 3)

ES207A-05 OF ES207A-09


171 OF 218




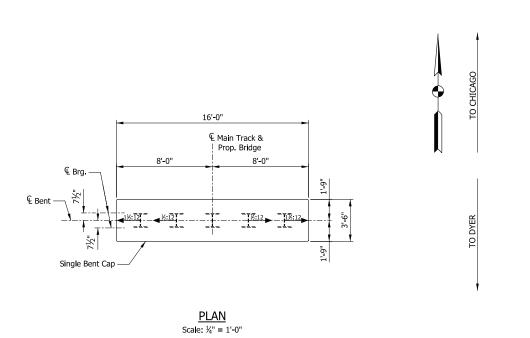

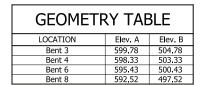

<u>PLAN</u> Scale: 1/4" = 1'-0"

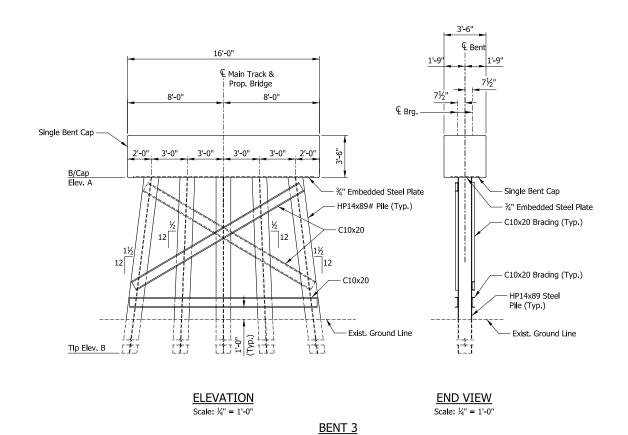

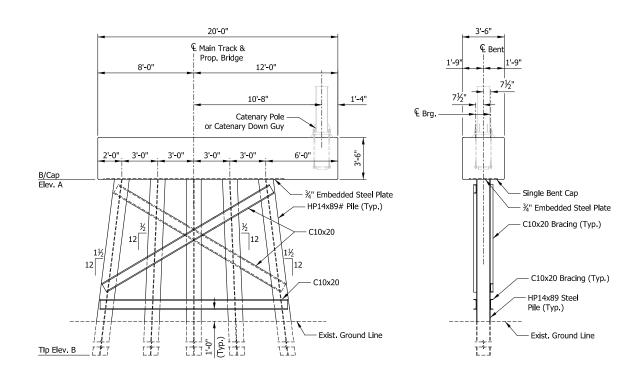


ELEVATION Scale: 1/4" = 1'-0"

END VIEW Scale: ½" = 1'-0"

BENTS 4, 6 & 8



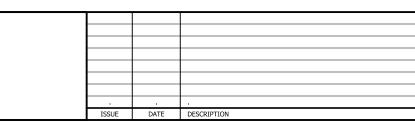






		NOT F	OR CONSTRUCTION	ES207A-06	OF	ES207A-09
DESIGNED:	HDR-PJG	NICTD - WEST LAKE CORRIDOR - MP WL 61.38 TO WL 69.18				
DRAWN:	HDR-AEP	SINGLE TRACK				
CHECKED:	HDR-PJG	ELEVATED STRUCTURE 207A				
DATE:	07/21/17					
		SUBSTRUCTURE DETAILS (3 OF 3)				
L OUTET						
		FILENAME	SHT_WL_ST_ES207A_SubstrDet_03	SHEET		
		SCALE	AS NOTED	172	OF .	218


PRELIMINARY PLANS

TO CHICAGO



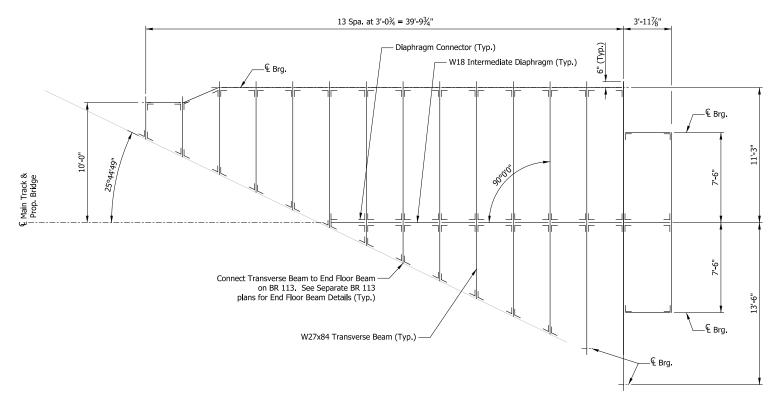

FRAMING PLAN Transverse Span Scale: ½" = 1'-0"

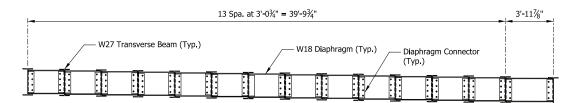

BEAM EXTERIOR ELEVATION

Transverse Span Scale: ½" = 1'-0"

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		NOT FOR CONSTRUCTION	SERIES		
_		HOT TOK CONSTRUCTION	ES207A-07	OF	ES207A-09
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		† ELEVATED STRU	CTURE 2	U/A	
DATE:	07/21/17				
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	NICTD - WEST LAKE CORRIDOR - MP WL 61.38 TO WL 69.18 SINGLE TRACK					
	ELEVATED STRUCTURE 207A					
	FRAMING PLAN (1 OF 3)					
ME	1E SHT_WL_ST_ES207A_FramPlan_01 SHEET					

FILENAM 173 OF 218 SCALE AS NOTED

PRELIMINARY PLANS

* Due to out-to-out beam spacing greater than 10'-0", diaphragms shall be designed to adequately distribute load from the track evenly to each beam, in accordance with the AREMA Manual.

PRELIMINARY PLANS

NOT FOR CONSTRUCTION SERIES ES207A-08 OF ES207A-09

DESIGNED:

DRAWN: HECKED:

DATE:

HDR-AEP

HDR-PJG

FILENAME

07/21/17

NICTD - WEST LAKE CORRIDOR - MP WL 61.38 TO WL 69.18 SINGLE TRACK

ELEVATED STRUCTURE 207A

FRAMING PLAN (2 OF 3)

SHT_WL_ST_ES207A_FramPlan_02 174 OF 218 AS NOTED

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TO CHICAGO

TO CHICAGO TO DYER 65'-9" End to End Beam 64'-9" & to & Brg. ——€ Brg. € Brg. -6 Spa. at 10'-9½" = 64'-9" Diaphragm Spacing 6 Spa. at 10'-9½" = 64'-9" Bracket Spacing - W36x330 Beam (Typ.) W36x135 End W36x135 Intermediate Diaphragm (Typ.) Diaphragm (Typ.) Track & Bridge 6'-1" — Diaphragm Plate (Typ.) - Diaphragm Connector € Main T Prop. (Typ.) — 90°0'0" (Тур.) —⅓" Bracket (Typ.) FRAMING PLAN Spans 3 thru 9 Scale: 1/4" = 1'-0" 65'-9" End to End Beam 64'-9" € to € Brg. ₽ Brg. W36x330 Beam € Brg. → — ½" Bracket (Typ.)

BEAM EXTERIOR ELEVATION

Spans 3 thru 9 Scale: ½" = 1'-0"

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DESIGNED:	HDR-PJG	
DRAWN:	HDR-AEP	
CHECKED:	HDR-PJG	
DATE:	07/21/17	
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NOT FOR CONSTRUCTION SERIES ES207A-09 OF ES207A-09 NICTD - WEST LAKE CORRIDOR - MP WL 61.38 TO WL 69.18 SINGLE TRACK

ELEVATED STRUCTURE 207A FRAMING PLAN (3 OF 3)


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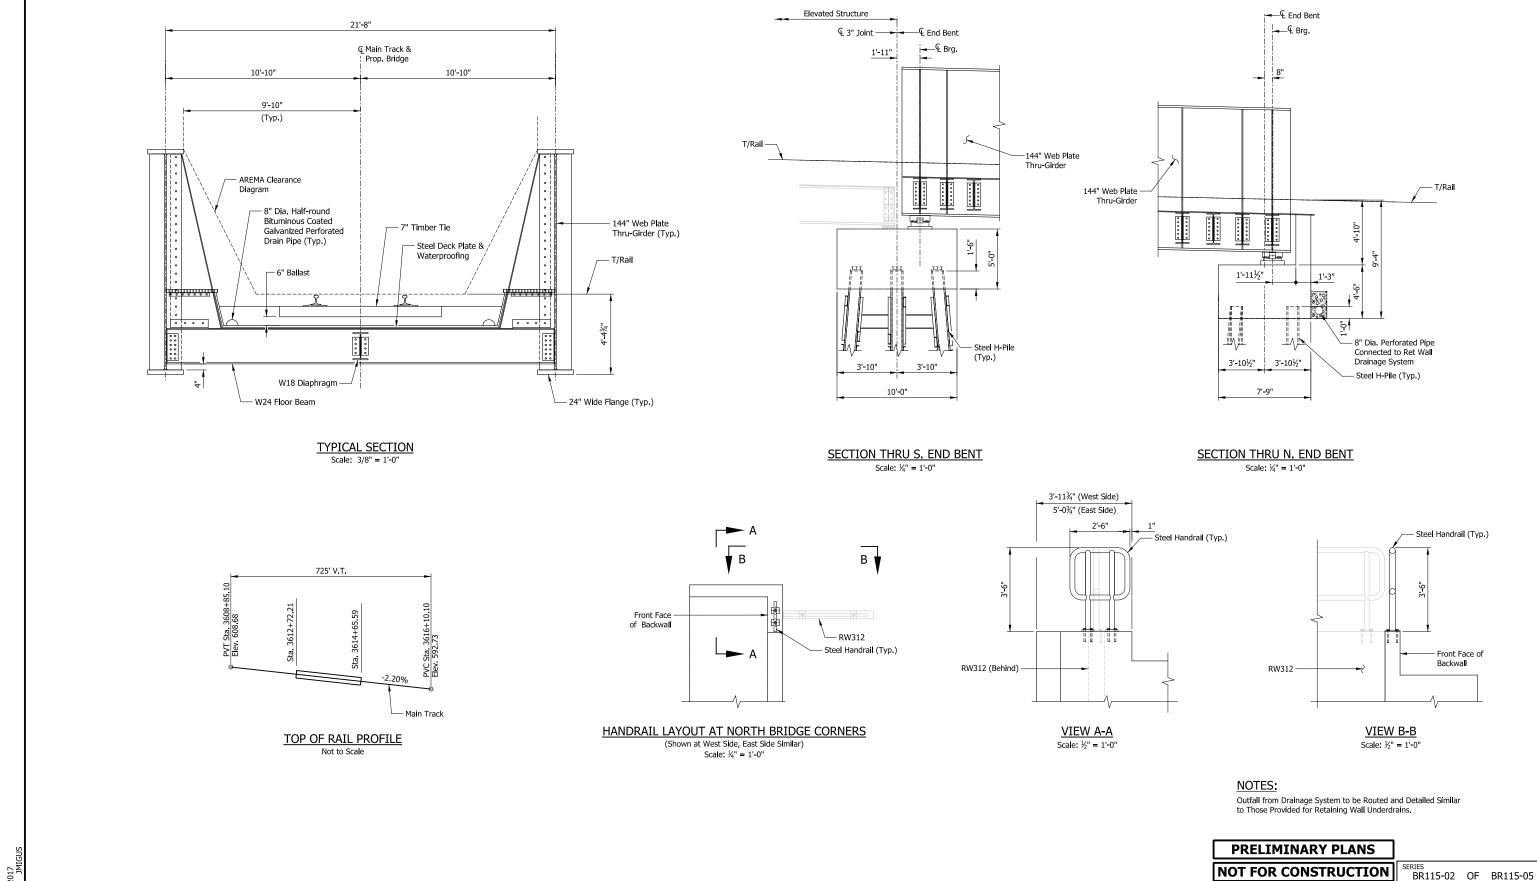
PRELIMINARY PLANS

SCALE

175 OF 218 AS NOTED


* Due to out-to-out beam spacing greater than 10'-0", diaphragms shall be designed to adequately distribute load from the track evenly to each beam, in accordance with the AREMA Manual.



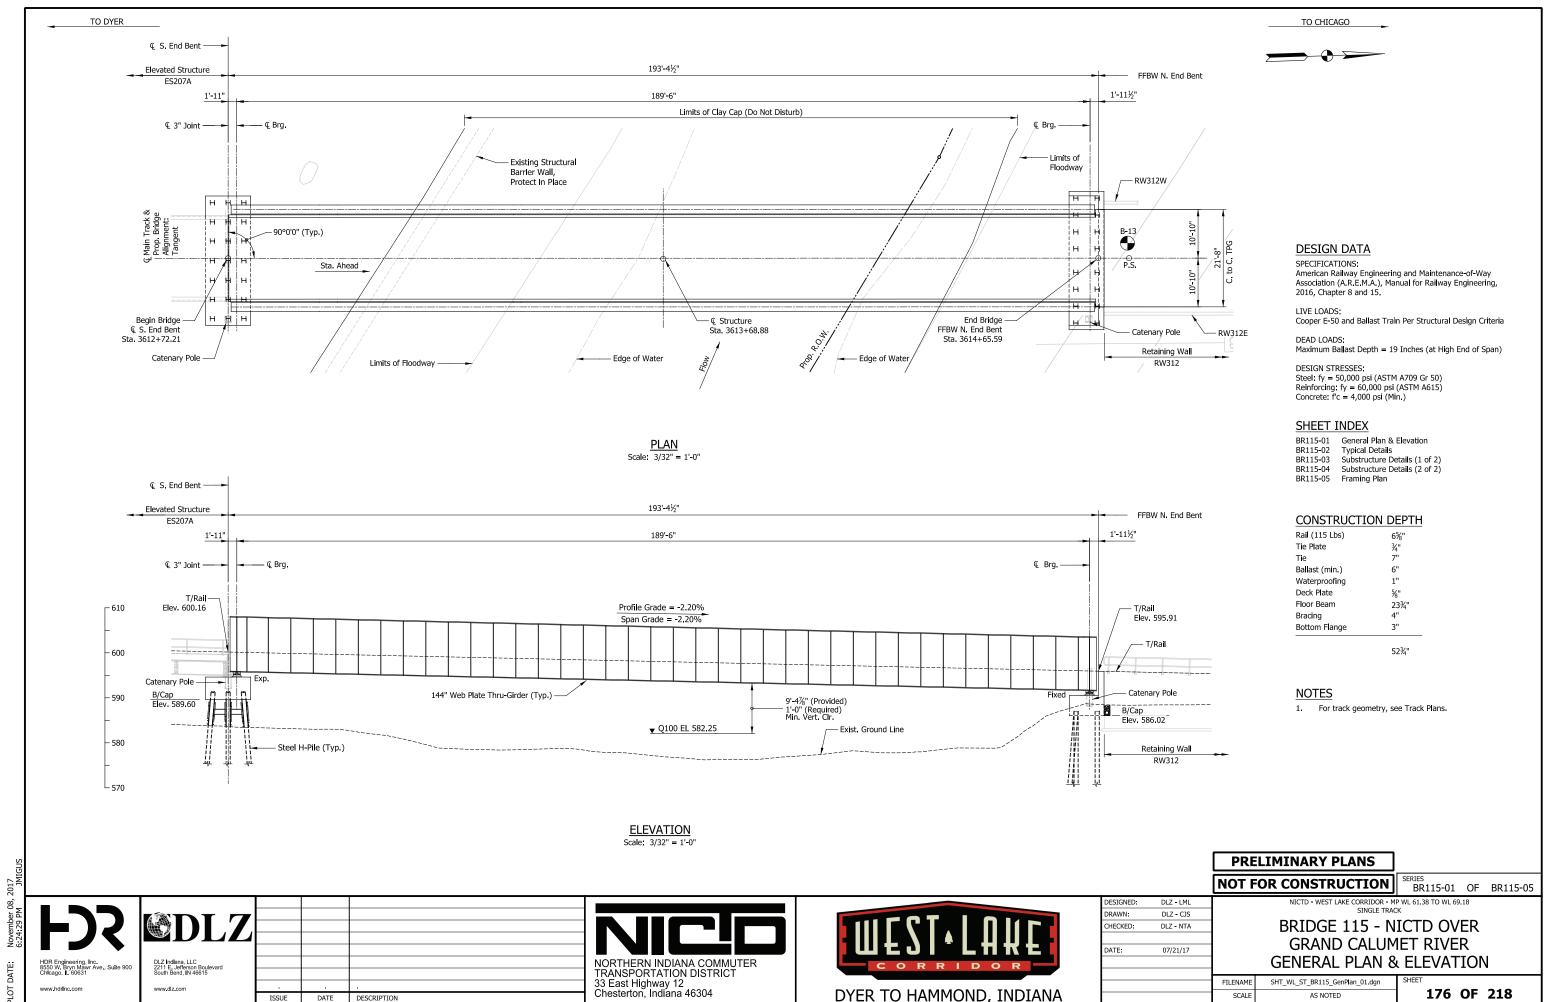

DATE: November 08, 2017 6:24:38 PM JMIGUS

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NORTHERN INDIANA COMMUTER TRANSPORTATION DISTRICT 33 East Highway 12 Chesterton, Indiana 46304

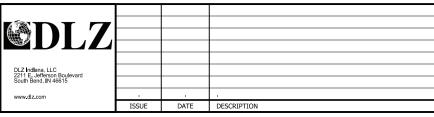


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DATE:	07/21/17	

NICTD - WEST LAKE CORRIDOR - MP WL 61.38 TO WL 69.18
SINGLE TRACK

BRIDGE 115 - NICTD OVER
GRAND CALUMET RIVER
TYPICAL DETAILS


FILENAME SHT_WL_ST_BR115_TypDet_01.dgn SCALE AS NOTED

177 OF 218

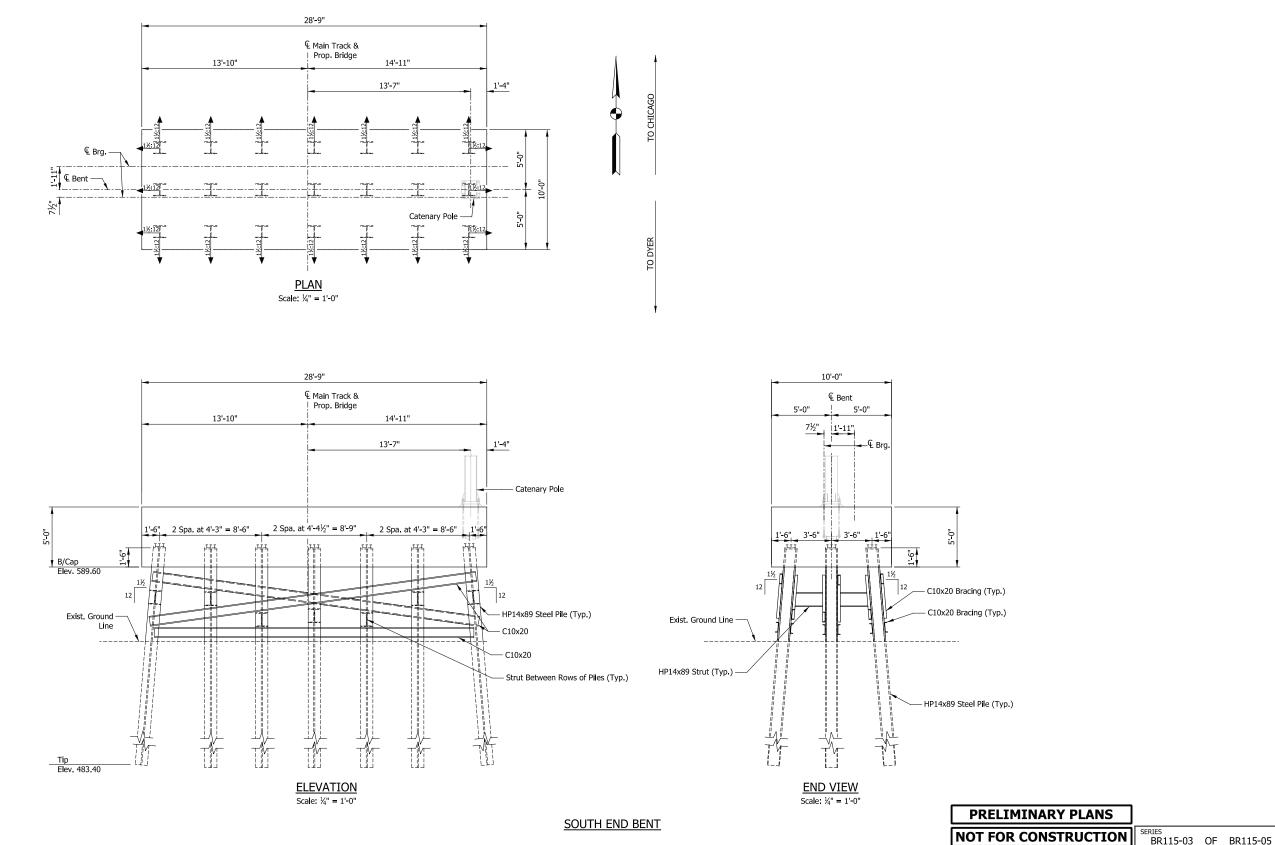

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HDR Engineering, Inc., 8550 W. Bryn Mawr Ave., Suite 900 Chteage, It. 60631

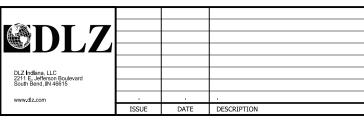


NORTHERN INDIANA COMMUTER TRANSPORTATION DISTRICT 33 East Highway 12 Chesterton, Indiana 46304




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NICTD - WEST LAKE CORRIDOR - MP WL 61.38 TO WL 69.18 SINGLE TRACK						
BRIDGE 115 - NICTD OVER						
GRAND CALUMET RIVER						
SUBSTRUCTURE DETAILS (1 OF 2)						
NAME SHT_WL_ST_BR115_SubstrDet_01.dgn	SHEET					
SCALE AS NOTED	178 OF 218					

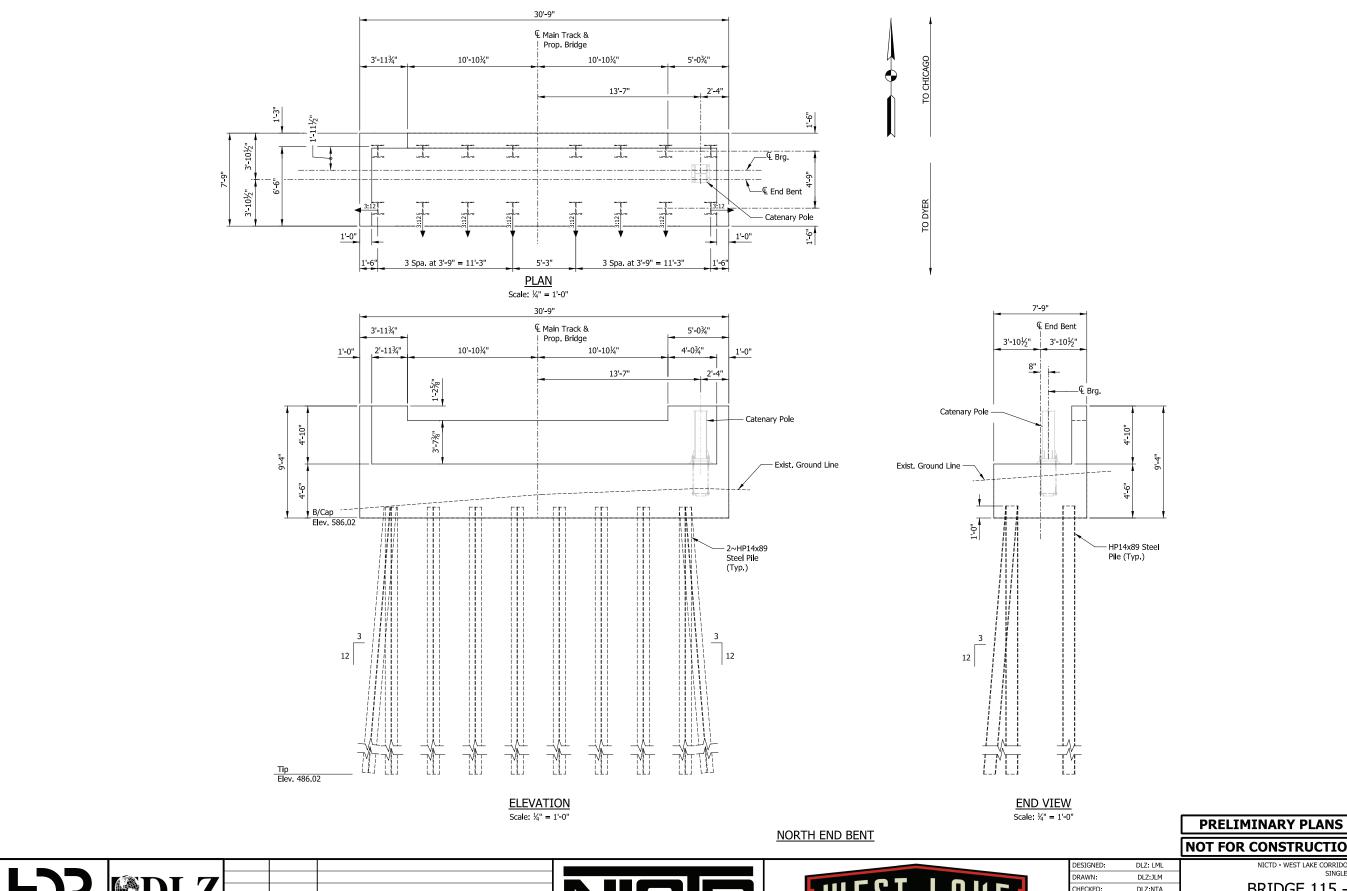

DATE: November 08, 2017

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	NOT FOR CONSTRUCTION	SERIES BR115-04	OF	BR115-05			
	NICTD - WEST LAKE CORRIDOR - MP WL 61.38 TO WL 69.18 SINGLE TRACK						
	BRIDGE 115 - NICTD OVER						
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AS NOTED


SHEET

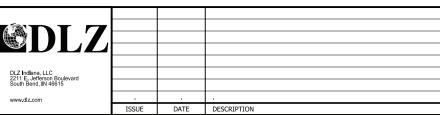179 OF 218

TO DYER TO CHICAGO 192'-6" End to End Girder 189'-6" € to € Brg. ---€ Brg. € Brg. /---- 2'-3" 2'**-**3" -74 Spa. at 2'-6" = 185'-0" Floor Beam Spacing Intermediate Stiffener/ 37 Spa. at 5'-0" = 185'-0" Walkway Support Spacing 7'**-**3" 9 Spa. @ 10'-0" = 90'-0" 8 Spa. @ 10'-0" = 80'-0" 7'-3" Knee Brace Spacing / W24x68 Interior Floor - W18x55 Diaphragm — 11"x11/8" Intermediate Stiffener 144" Web Plate - Walkway Support (Typ.) Beam (Typ.) (Typ.) (Typ.) Thru-Girder (Typ.) — 6"x1⅓" Bearing Stiffener Main Track & Prop. Bridge (Typ. @ End Floor Beams) - 90°0'0" (Typ.) - W24x192 End Floor Beam (Typ.) · 11"x1¾" Bearing Stiffener Knee Brace (Typ.) — (Typ.) FRAMING PLAN Scale: 1/8" = 1'-0" 192'-6" End to End Girder 1'-6" 189'-6" € to € Brg. € Brg. **-**—€ Brg. — Bearing Stiffener (Typ.) – 24" x 3" Flange Plate - Intermediate Stiffener (Typ.) —1⅓" Web Plate - 24" x 3" Flange Plate **GIRDER EXTERIOR ELEVATION** Scale: ½" = 1'-0" PRELIMINARY PLANS NOT FOR CONSTRUCTION BR115-05 OF BR115-05 NICTD - WEST LAKE CORRIDOR - MP WL 61.38 TO WL 69.18 SINGLE TRACK

DATE: November 08, 2017

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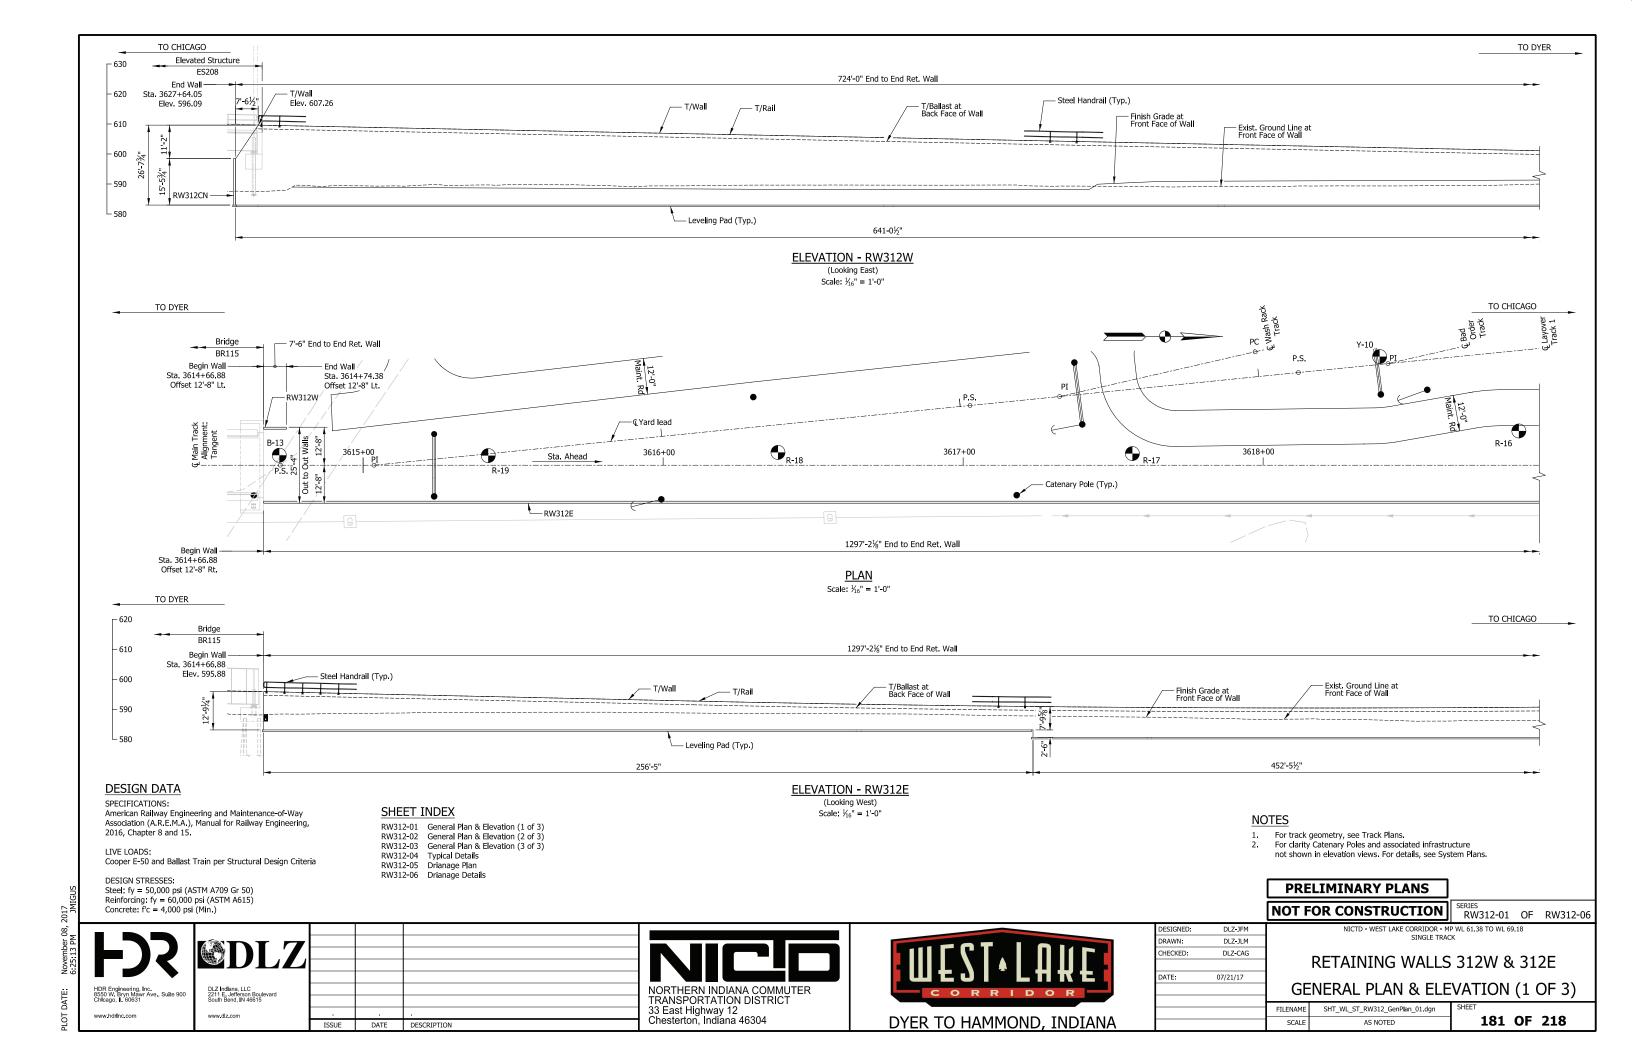


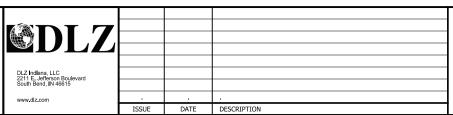
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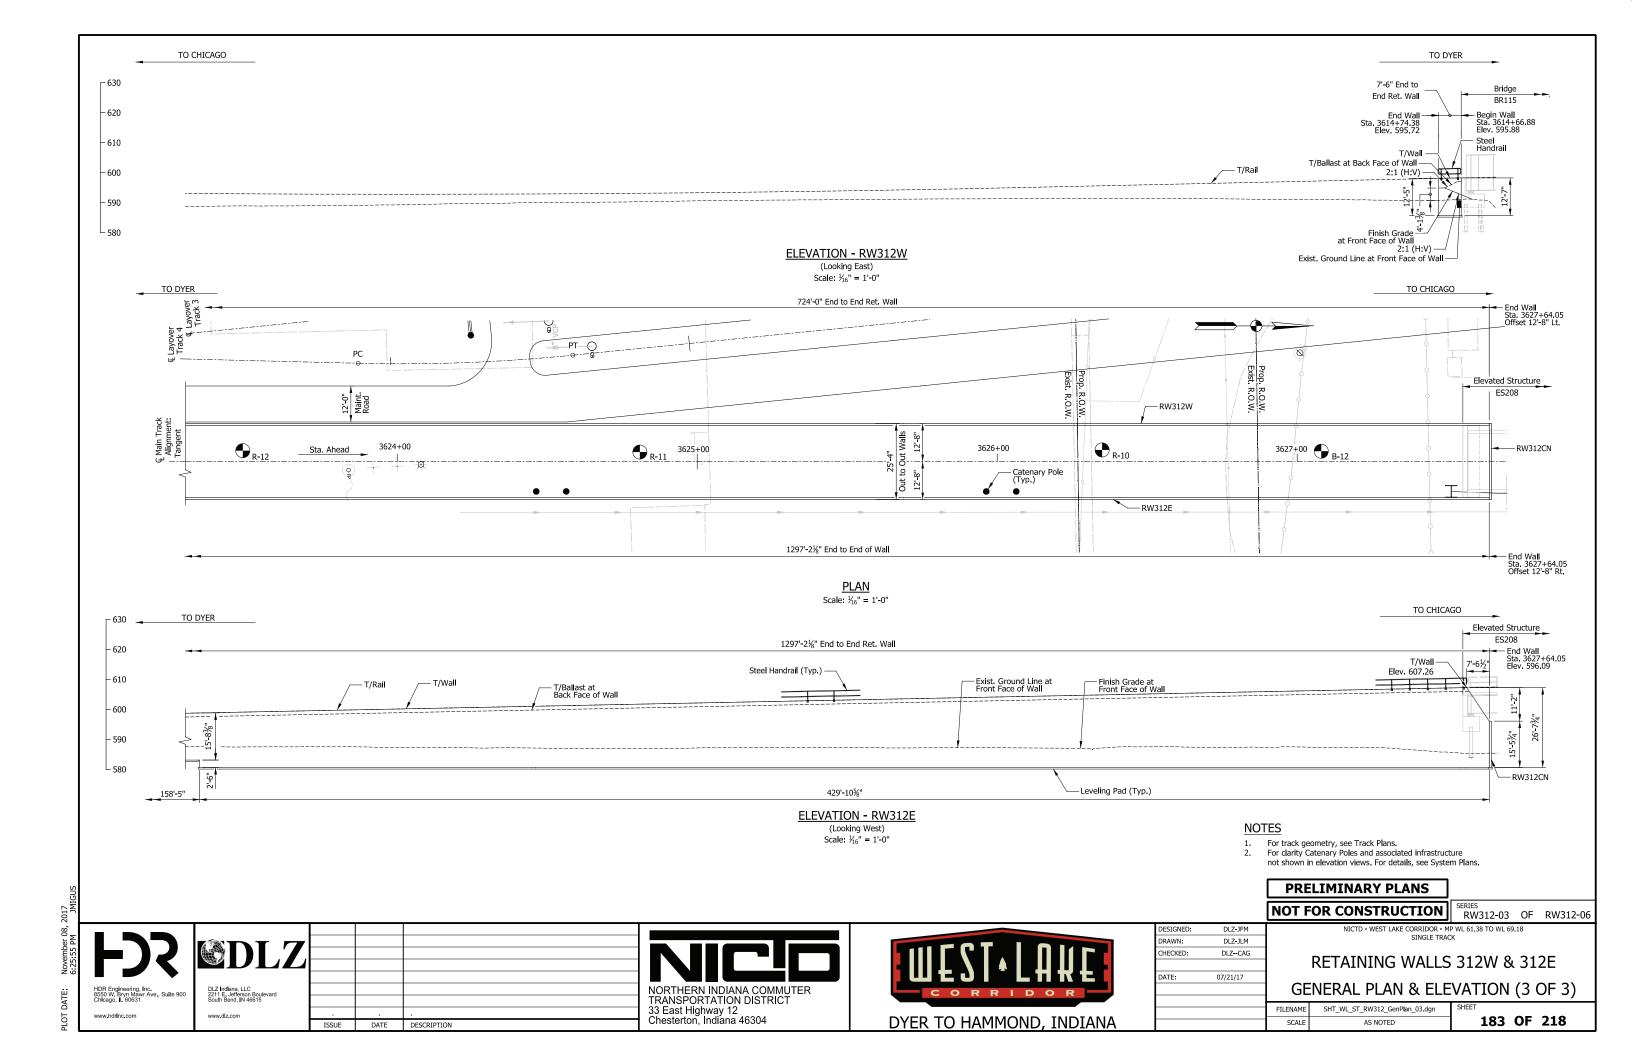
BRIDGE 115 - NICTD OVER
GRAND CALUMET RIVER
FRAMING PLAN


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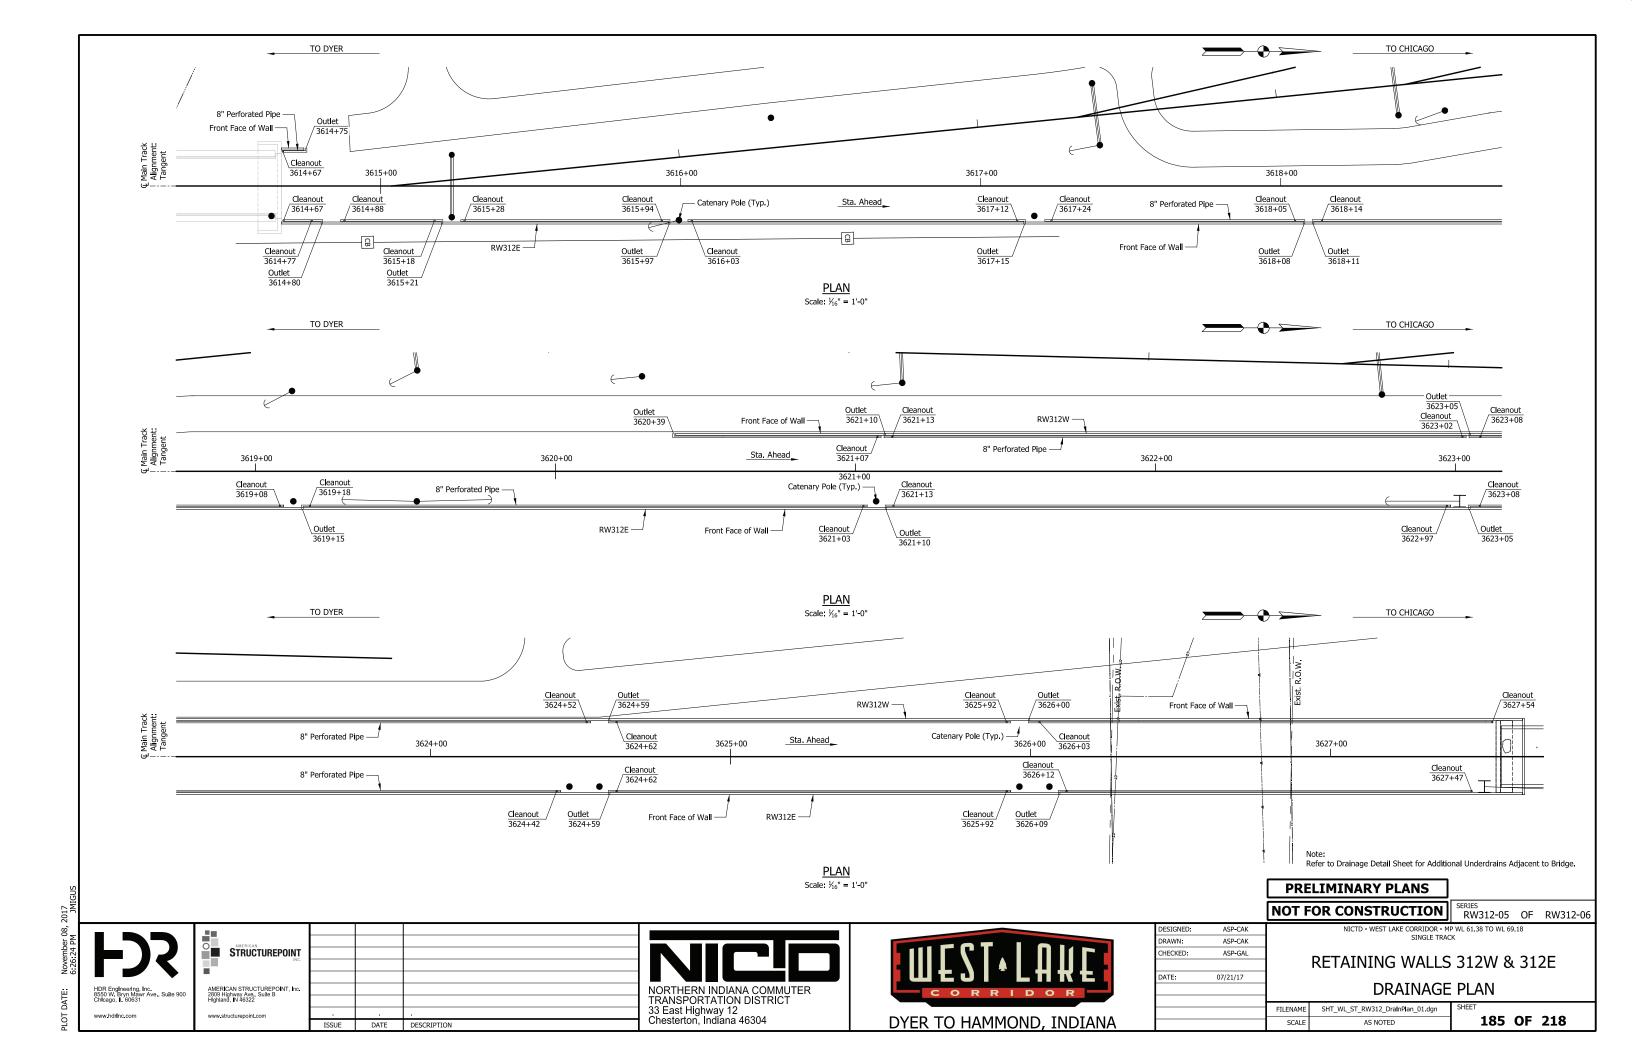
180 OF 218









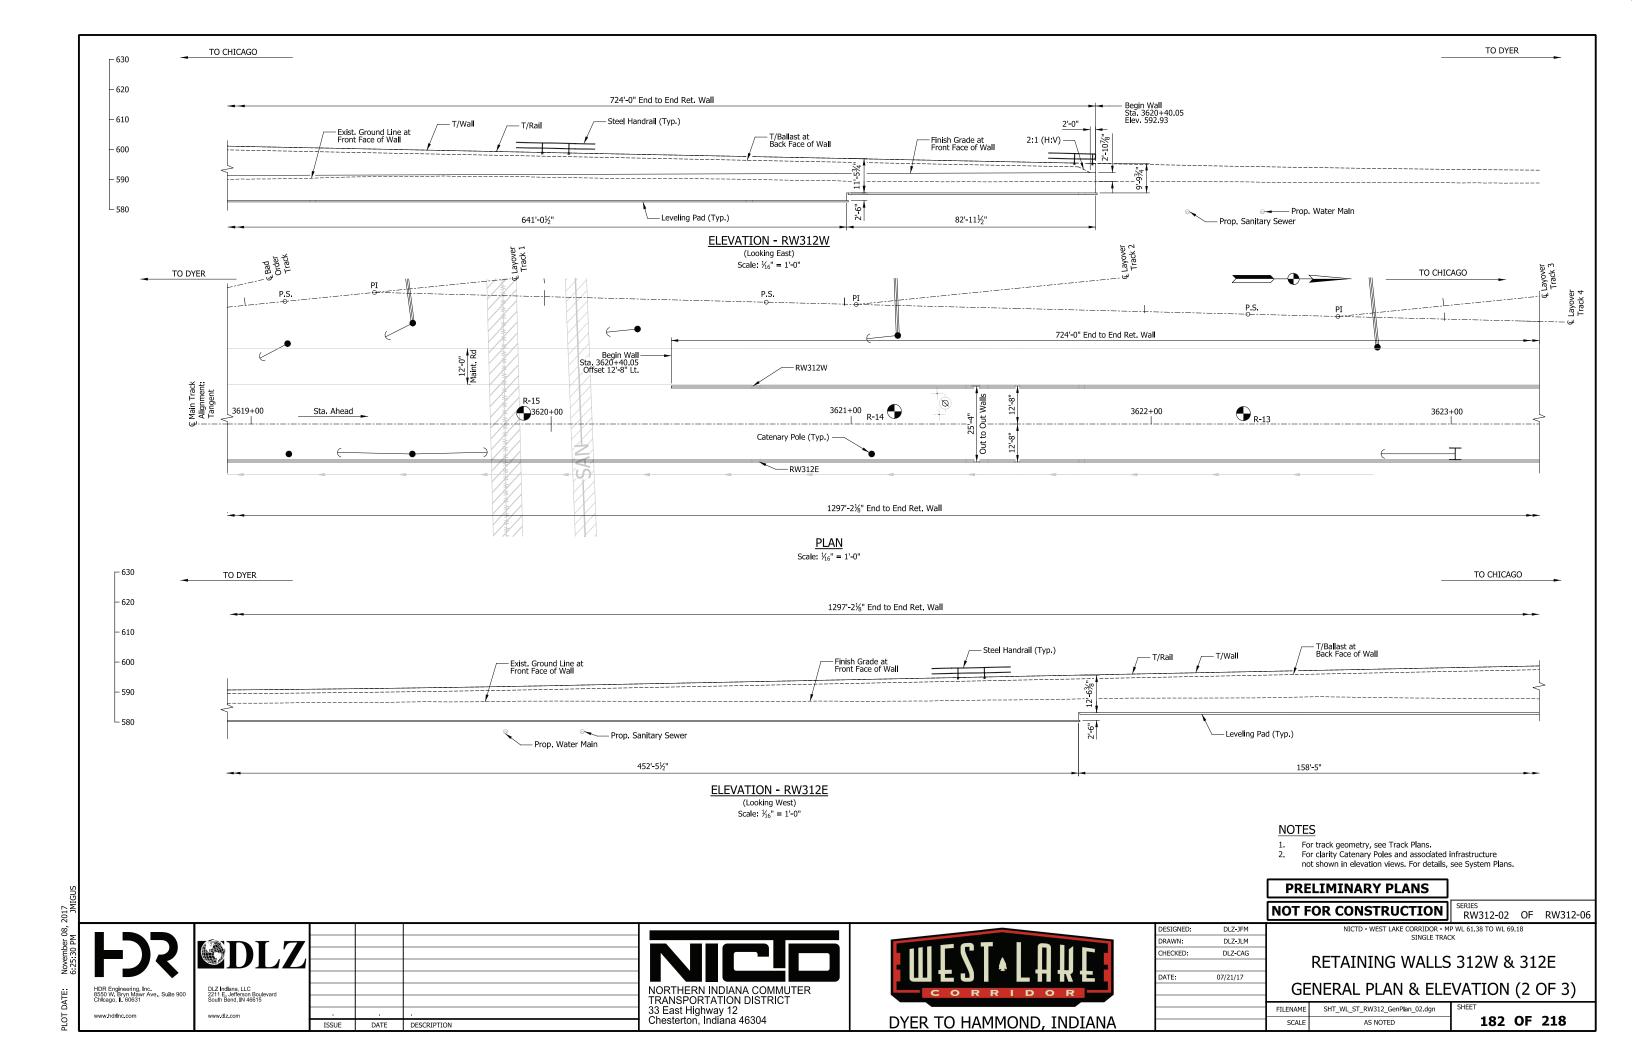

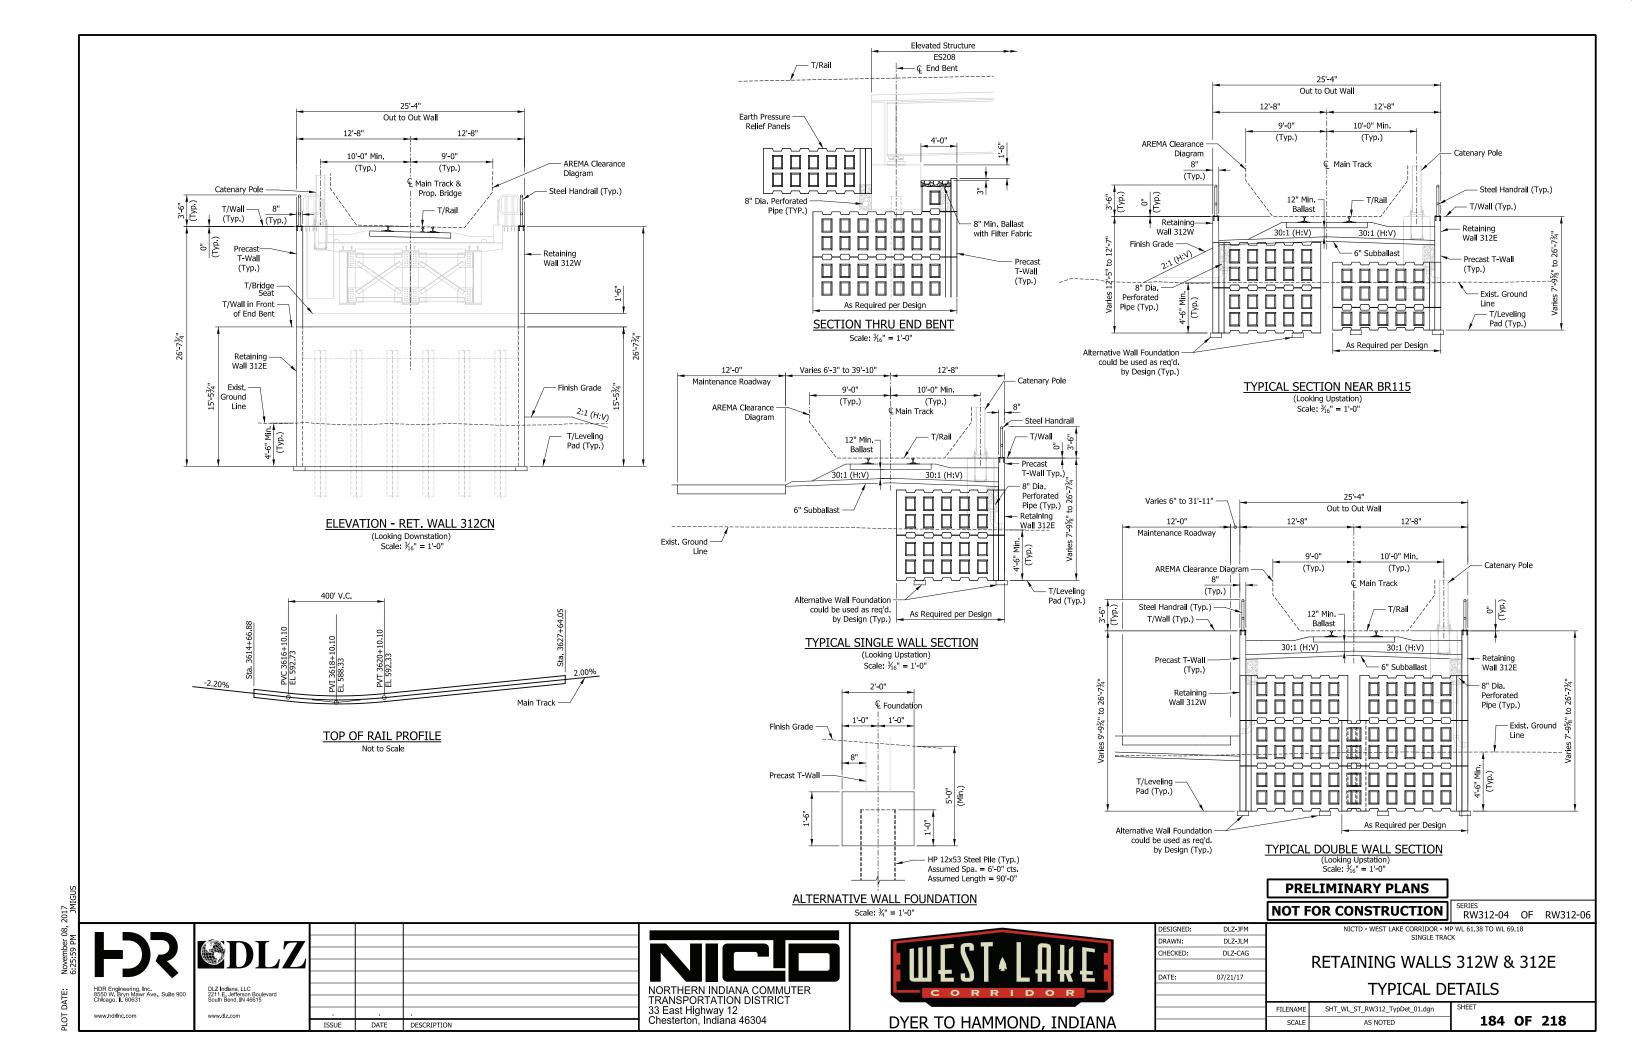


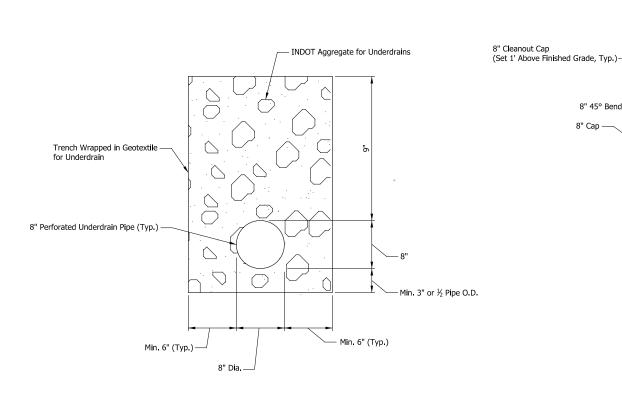

TYPICAL UNDERDRAIN SECTION

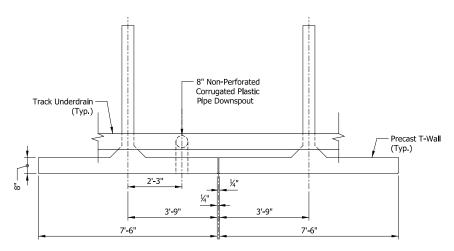

TYPICAL WALL PENETRATION DETAIL

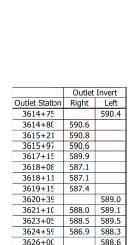

Upstream

8" 45° Bend

UNDERDRAIN OUTLET ELEVATION SUMMARY TABLE

3626+09 586.5

8" Dia. Tee, (Typ.) 8" Dia. Cleanout, (Typ.) -8" Dia. Perf. Pipe, See Bridge / Elevated Structure Typical Details, (Typ.) -

200' (Typ.)

Slope to Match Rail Grade

2. All Fittings, Cleanout Piping, and Vertical Piping Shall Be Solid Wall.

shall Occur at Locations Shown per Typical Wall Penetration Detail.

Type 2 And Rodent Screen.

8" Perforated Pipe (Typ.) —

Provide Underdrain As Shown In Retaining Wall Typical Section Detail and Retaining Wall Drainage Plans.

At Downstream Limits Of Wall, Daylight Underdrain To Side Ditch With INDOT Outlet Protector,

Select Locations at Low Points in Rail Underdrain Profile May Include One Outlet Serving Underdrain Upstream in Both Directions. Provide Additional Fittings as Required. See Plan View for Locations. Outlet Station Location in Plan View are Approximate. Final Constructed Outlet Stations / Wall Penetrations

TYPICAL TRACK UNDERDRAIN SCHEMATIC AT RETAINING WALLS Scale: Not to Scale

Connect to Vertical Downspout Section

Outlet Through Wall Penetration, (Typ.)

8" Dia. Cleanout w/45° Fittings to Vertical Downspout Section, (Typ.)

with Solid 8" Piping, (Typ.)

8" Dia. Perf. Pipe; Connect to Vertical Downspout Section with Solid 8" Vertical Piping and Fittings, (Typ.) TYPICAL UNDERDRAIN PLAN DETAIL AT RETAINING WALL INTERFACE WITH BRIDGE OR ELEVATED STRUCTURE

8" Dia. Cleanout, (Typ.) -

PRELIMINARY PLANS NOT FOR CONSTRUCTION

Outlet Through Wall Penetration, (Typ.)

- 8" Dia, Cleanout w/45° Fittings

to Vertical Downspout Section, (Typ.)

Downstream _

8" 45° Bend -

8" 90° Bend -

8" Cleanout Cap

8" 45° Bend

Outlet Through Wall Penetration With Rodent Grate At Elevation Shown in Summary Table. Provide

See Bridge / Elevated Structure Typical Details, (Typ.)

5'x5' Revetment Riprap On Geotextiles At All Unpaved Wall Outlet Locations

- 8" 90° Bend with Cleanout, (Typ.)

8" Cleanout Cap

8" 45° Bend

See Note

RW312-06 OF RW312-06

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STRUCTUREPOINT AMERICAN STRUCTUREPOINT, Inc. 2809 Highway Ave., Suite B Highland, IN 46322 www.structurepoint.com DATE DESCRIPTION

NORTHERN INDIANA COMMUTER TRANSPORTATION DISTRICT 33 East Highway 12 Chesterton, Indiana 46304



DRAWN: ASP-CAK CHECKED: ASP-GAL			
CHECKED: ASP-GAL	DESIGNED:	ASP-CAK	
	DRAWN:	ASP-CAK	
DATE: 07/21/17	CHECKED:	ASP-GAL	
DATE: 07/21/17			
	DATE:	07/21/17	

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NICTD - WEST LAKE CORRIDOR - MP WL 61.38 TO WL 69.18 SINGLE TRACK


RETAINING WALLS 312W & 312E


Fransition 8" Dia. Half-Round Bridge Drain Pipe to 8" Dia. Solid Pipe. See Bridge / Elevated Structure Typical Details for Cont., (Typ.)


See Bridge / Elevated Structure Typical Details, (Typ.)

DRAINAGE DETAILS

SHT_WL_ST_RW312_DraInDet_01.dgn 186 OF 218 AS NOTED

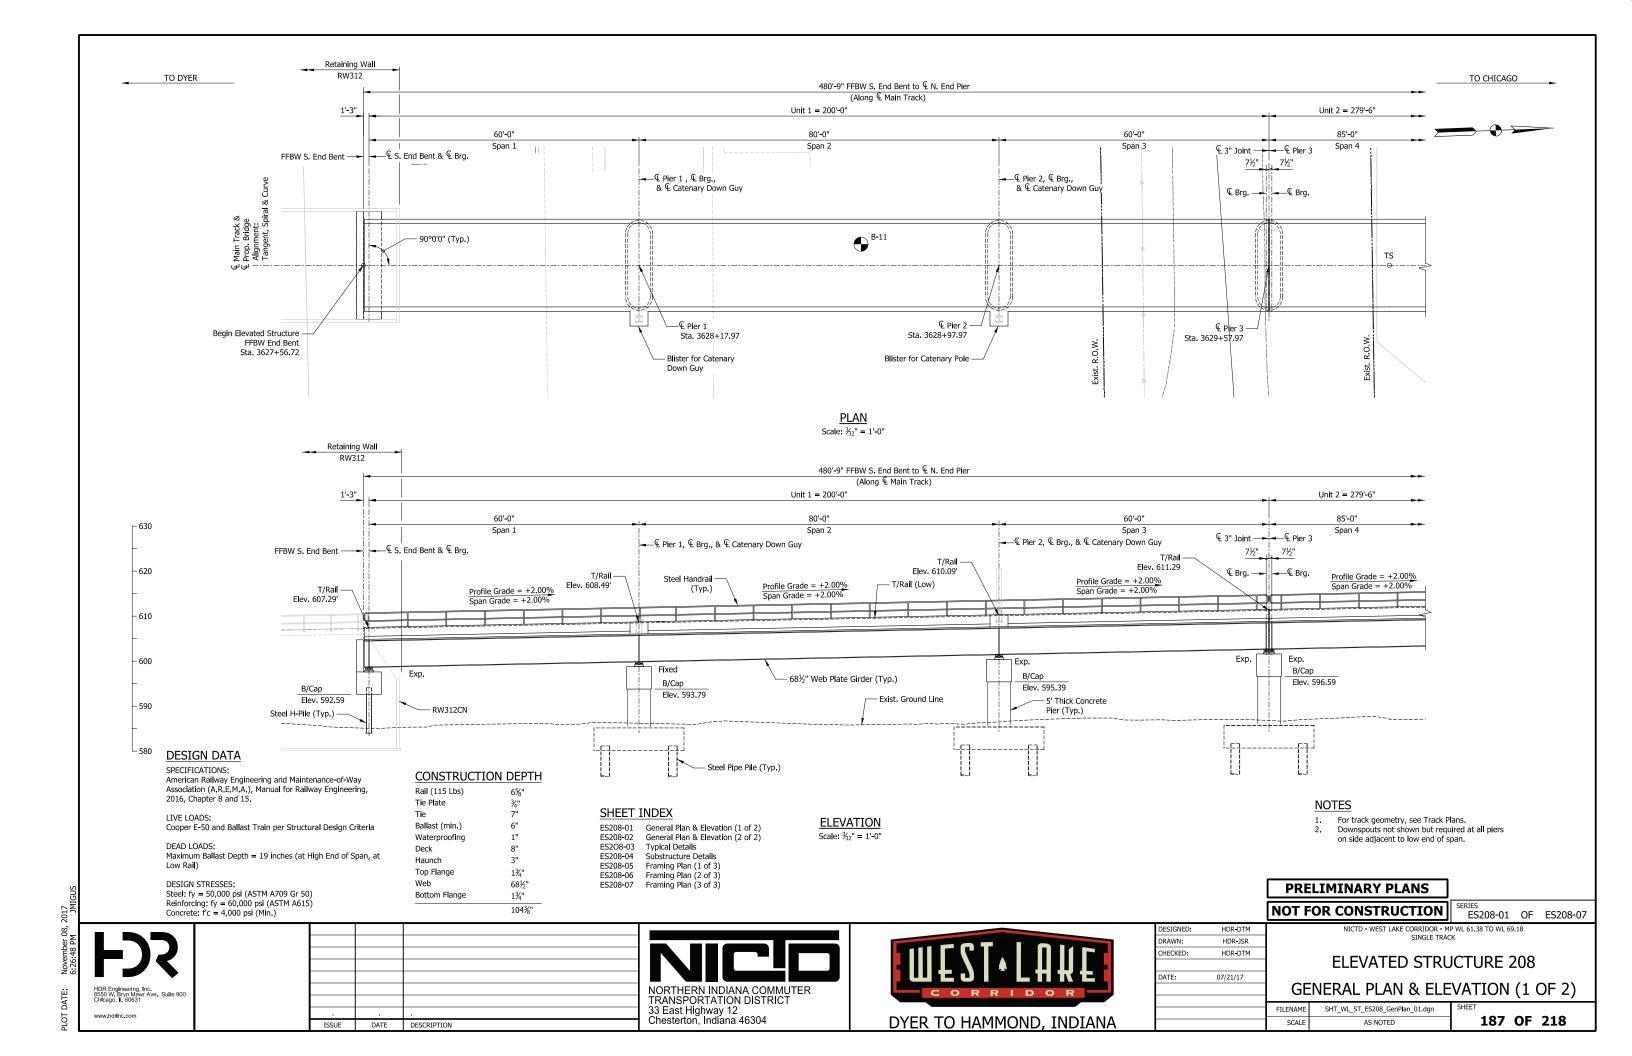

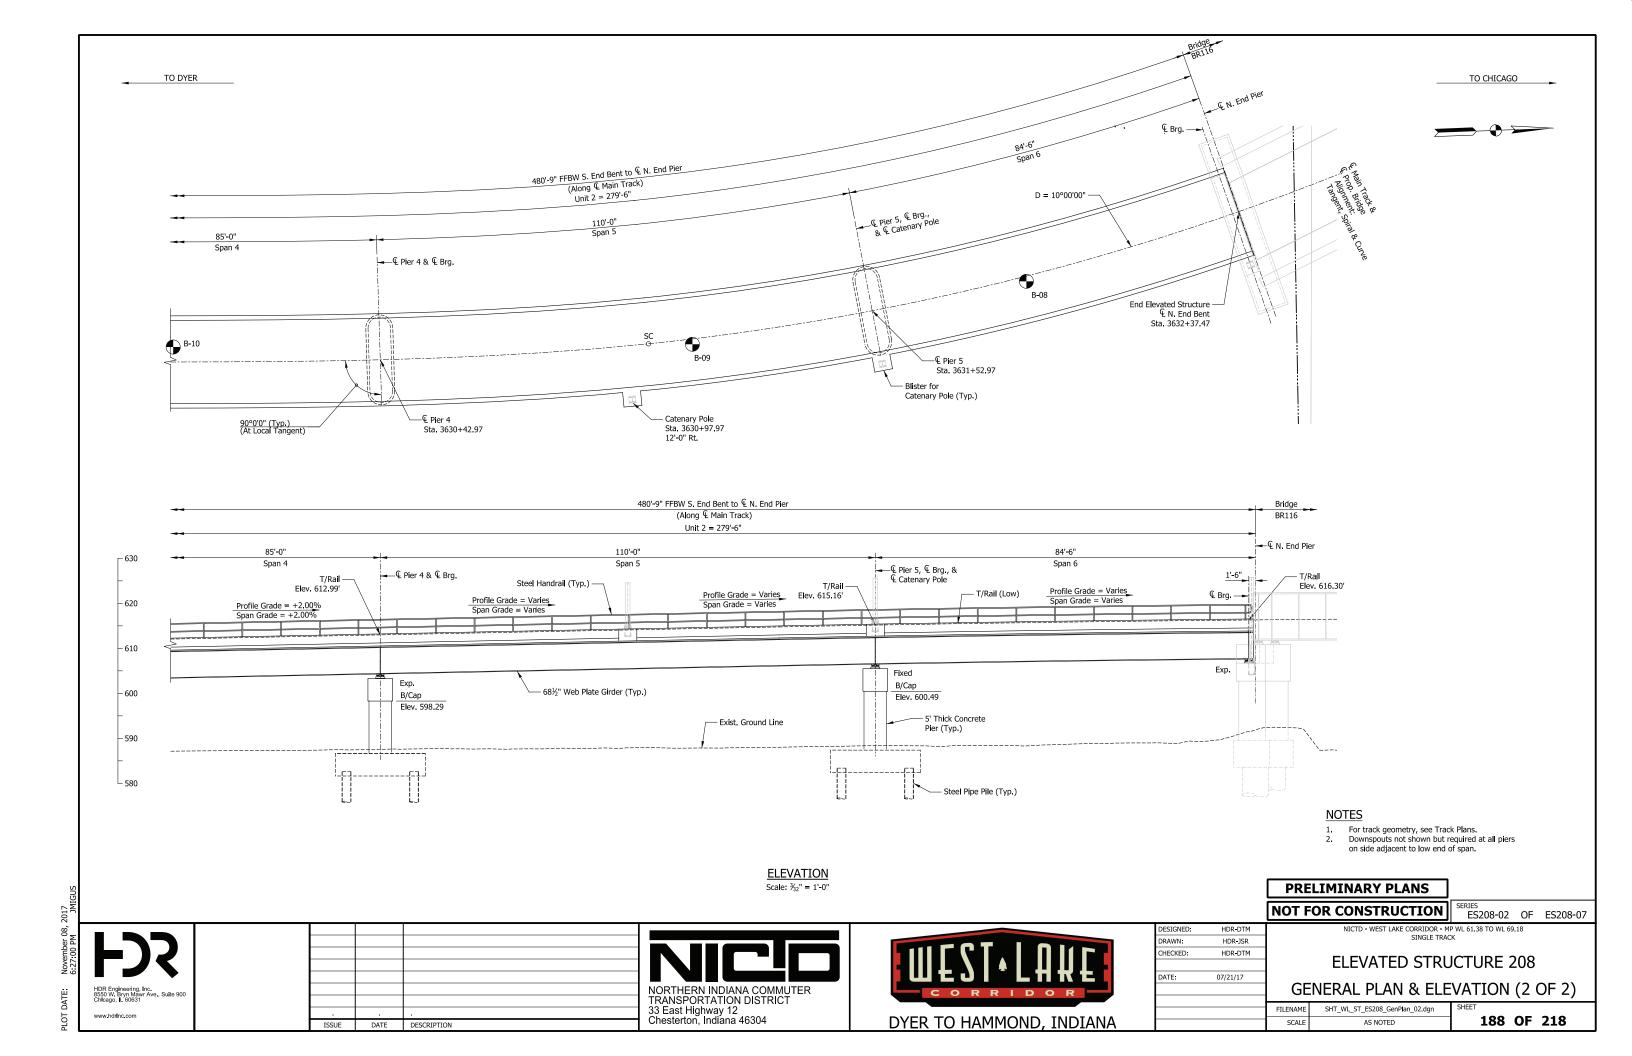

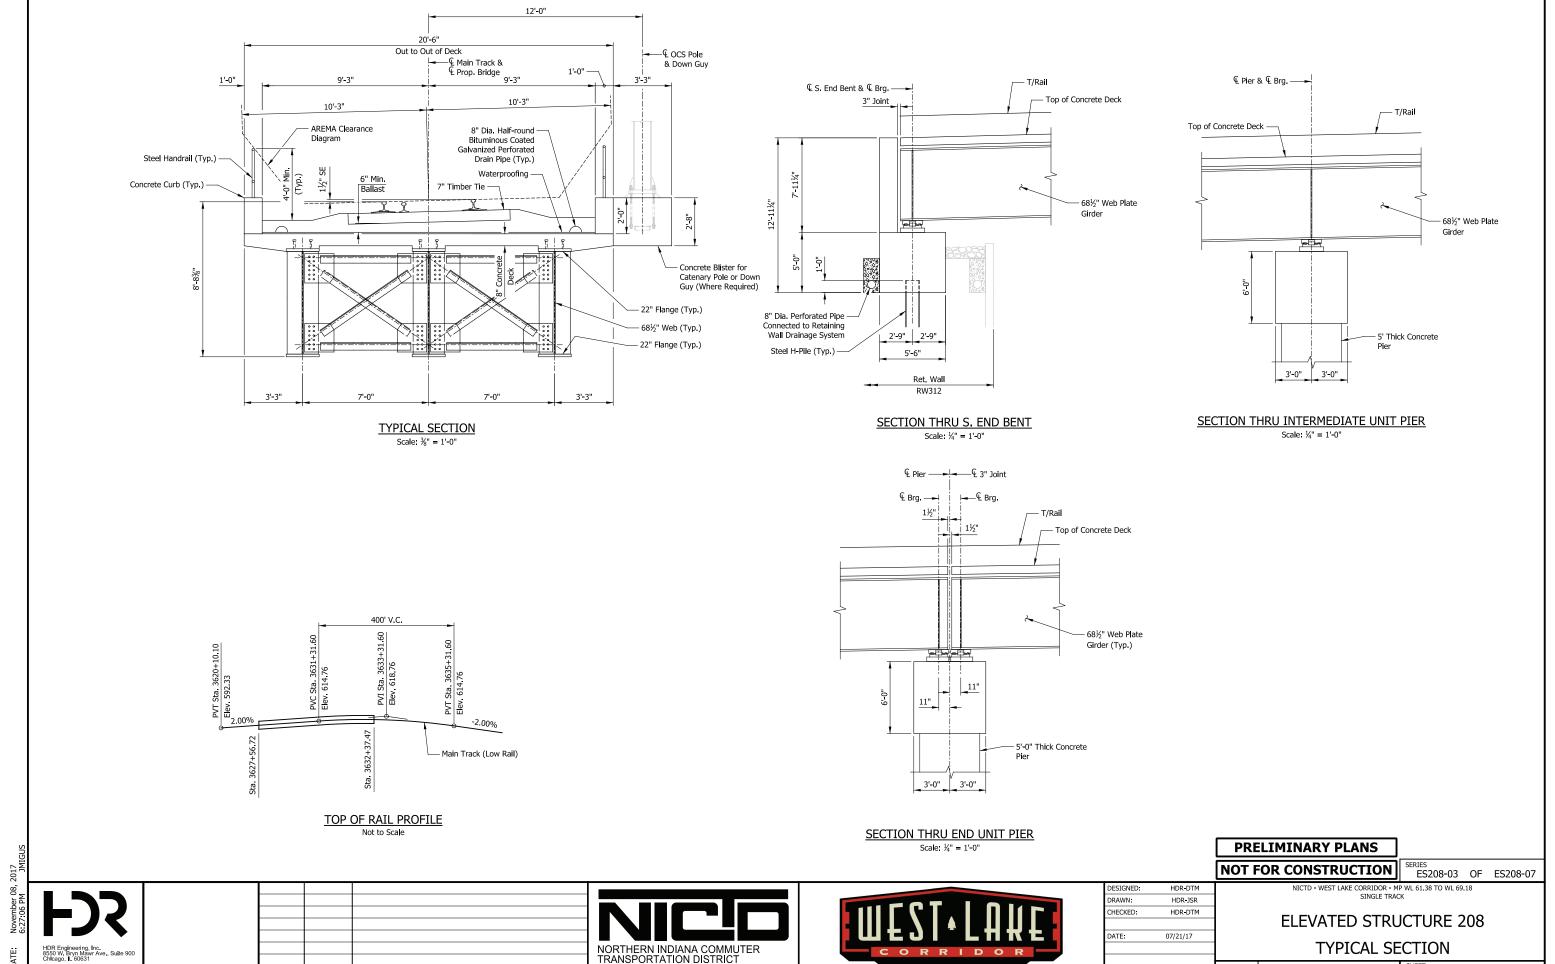

DYER TO HAMMOND, INDIANA

FILENAME

SHT_WL_ST_ES208_TypDet_01.dgn


AS NOTED

189 OF 218

33 East Highway 12 Chesterton, Indiana 46304


www.hdrinc.com

DATE DESCRIPTION

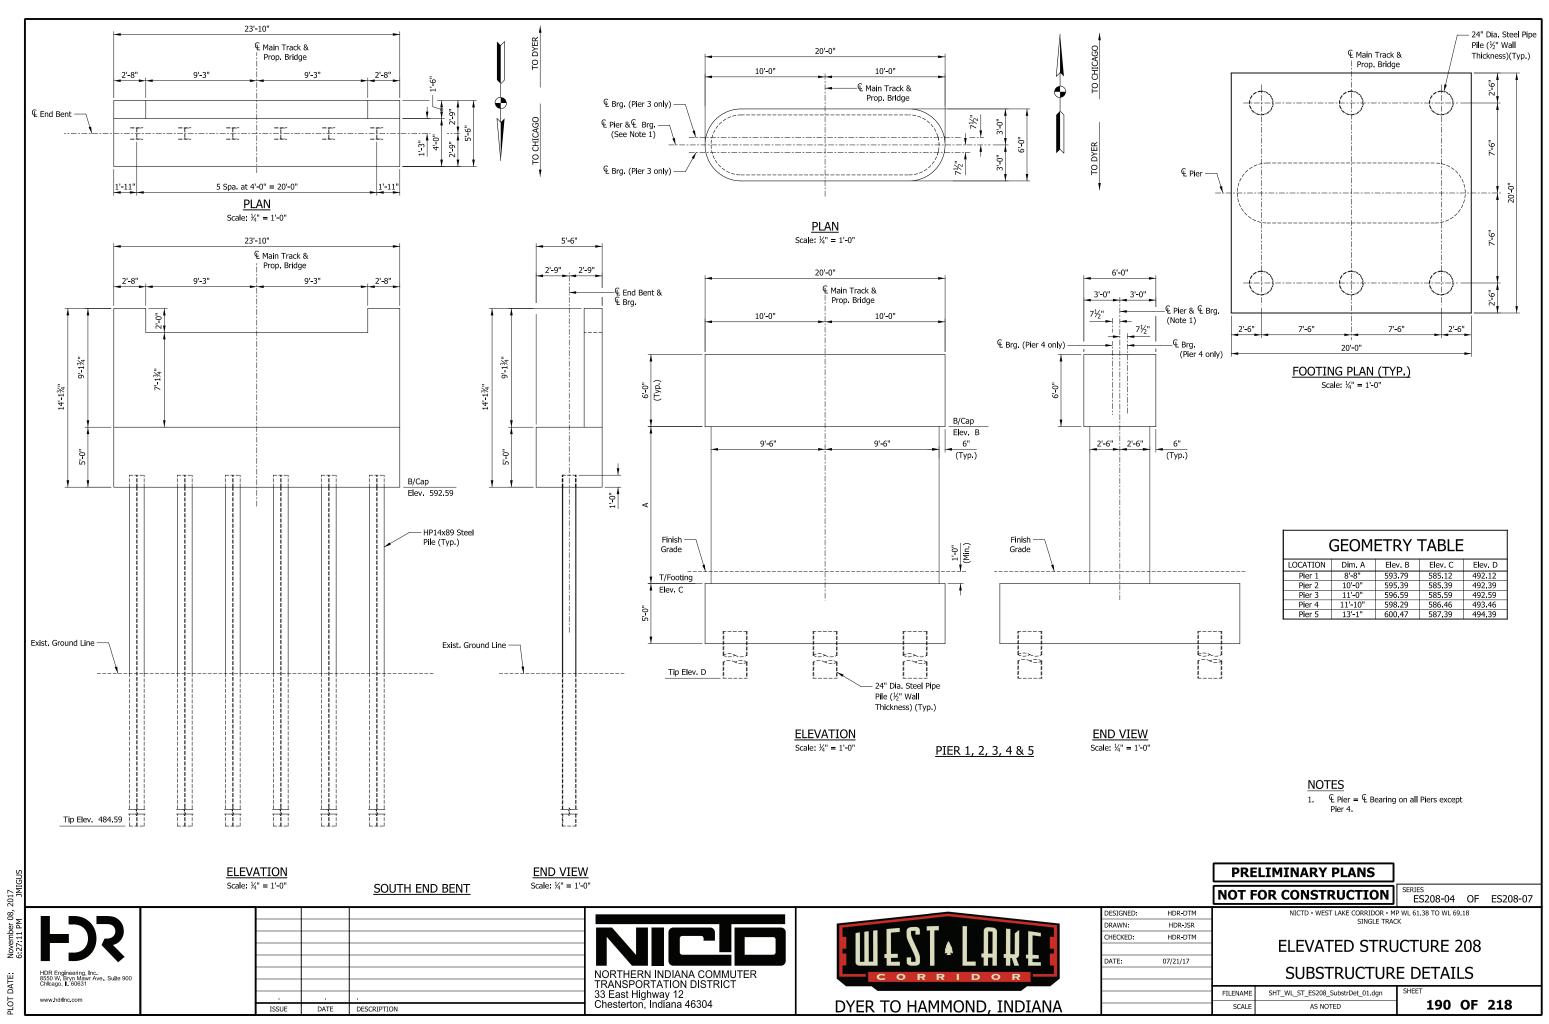

TO DYER TO CHICAGO 200'-10½" End to End Girder Unit 1 199'-4½" € to € Brg. 1'-0" 3 Spa. at 19'-9½" = 59'-10½" Diaphragm Spacing 3 Spa. at 20'-0" = 60'-0" 4 Spa. at 20'-0" = 80'-0" S. End Bent & & Brg. ← L Pier 1 & L Brg. ← L Pier 2 & L Brg. € Brg. → — End Diaphragm (Typ.) Intermediate
 Cross Frame (Typ.) – Pier Diaphragm (Typ.) Bearing Stiffener (Typ.) -<u>PLAN</u> Scale: ½" = 1'-0" 200'-10½" End to End Girder Unit 1 199'-4½" € to € Brg. 1'-0" € Brg. — ← ---- € S. End Bent & € Brg. ← Pier 2 & € Brg. —— 22"x1¾" Flange ₽ Pier 1 & ₽ Brg. -¾" Web Plate - Bearing Stiffener (Typ.) — 22"x1¾" Flange **ELEVATION** Scale: ½" = 1'-0"

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		NOT F	OR CONSTRUCTION	SERIES ES208-05	OF ES208-07	
DESIGNED:	HDR-DTM		NICTD - WEST LAKE CORRIDOR - M		.18	
DRAWN:	HDR-JSR		SINGLE TRAC	CK		
CHECKED:	HDR-DTM		ELEVATED CTDL	ICTUDE 3		
			ELEVATED STRUCTURE 208			
DATE:	07/21/17					
			FRAMING PLAI	N (1 OF 3	3)	
					/	_
		FILENAME	SHT_WL_ST_ES208_FramPlan_01.dgn	SHEET		
		SCALE	AS NOTED	191	OF 218	

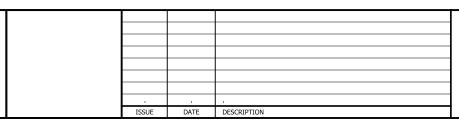PRELIMINARY PLANS

TO DYER 278'-4½" End to End Girder (at € Bridge) 277'-10½" & to & Brg. (at & Bridge) 5 Spa. at 22'-0" = 110'-0" (at ♀ Bridge) 4 Spa. at 21'-1⅓" = 84'-4½" (at € Bridge) Diaphragm Spacing € Pier 4 & € Brg. — ₽ Brg. 90°0'0" (at local tangent) — Intermediate
 Cross Frame (Typ.) - End Diaphragm (Typ.) - Pier Diaphragm (Typ.) Bearing Stiffener (Typ.) -<u>PLAN</u> Scale: ½" = 1'-0" 278'-4½" End to End Girder (at € Bridge) Unit 2 277'-10½" & to & Brg. (at & Bridge) **⊸**—€ Вгд. € Pier 4 & € Brg. —► – 22"x1¾" Flange ──¾" Web Plate – Bearing Stiffener (Typ.) – 22"x1¾" Flange ELEVATION
Scale: ½" = 1'-0"

PRELIMINARY PLANS

NOT FOR CONSTRUCTION

ES208-06 OF ES208-07

TO CHICAGO

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DESIGNED:	HDR-DTM		
DRAWN:	HDR-JSR		
CHECKED:	HDR-DTM		
DATE:	07/21/17		
			_
		FILENAME	

ELEVATED STRUCTURE 208


FRAMING PLAN (2 OF 3)

SHT_WL_ST_ES208_FramPlan_02.dgn 192 OF 218 AS NOTED

TO DYER TO CHICAGO 278'-4½" End to End Girder (at € Bridge) Unit 2 277'-10½" ♀ to ♀ Brg. (at ♀ Bridge) 5 Spa. at 22'-0" = 110'-0" (at ♀ Bridge) 4 Spa. at 21'-0" = 84'-0" (At 4 Bridge) - 90°0'0" (at local tangent) € N. End Bent & € Brg. — ← L Pier 5 & L Brg. - 90°0'0" (at local tangent) End Diaphragm (Typ.) — Pier Diaphragm (Typ.) — Bearing Stiffener (Typ.) — <u>PLAN</u> Scale: ½" = 1'-0" 278'-4½" End to End Girder (at € Bridge) Unit 2 277'-10½" ♀ to ♀ Brg. (at ♀ Bridge) 1'-0" Pier 5 & & Brg. — 22"x1¾" Flange Plate € N. End Bent & € Brg. — Bearing Stiffener (Typ.) – −¾" Web Plate 22"x1¾" Flange Plate **ELEVATION** Scale: ½" = 1'-0" PRELIMINARY PLANS NOT FOR CONSTRUCTION SERIES ES208-07 OF ES208-07

PLOT DATE: November 08, 2017

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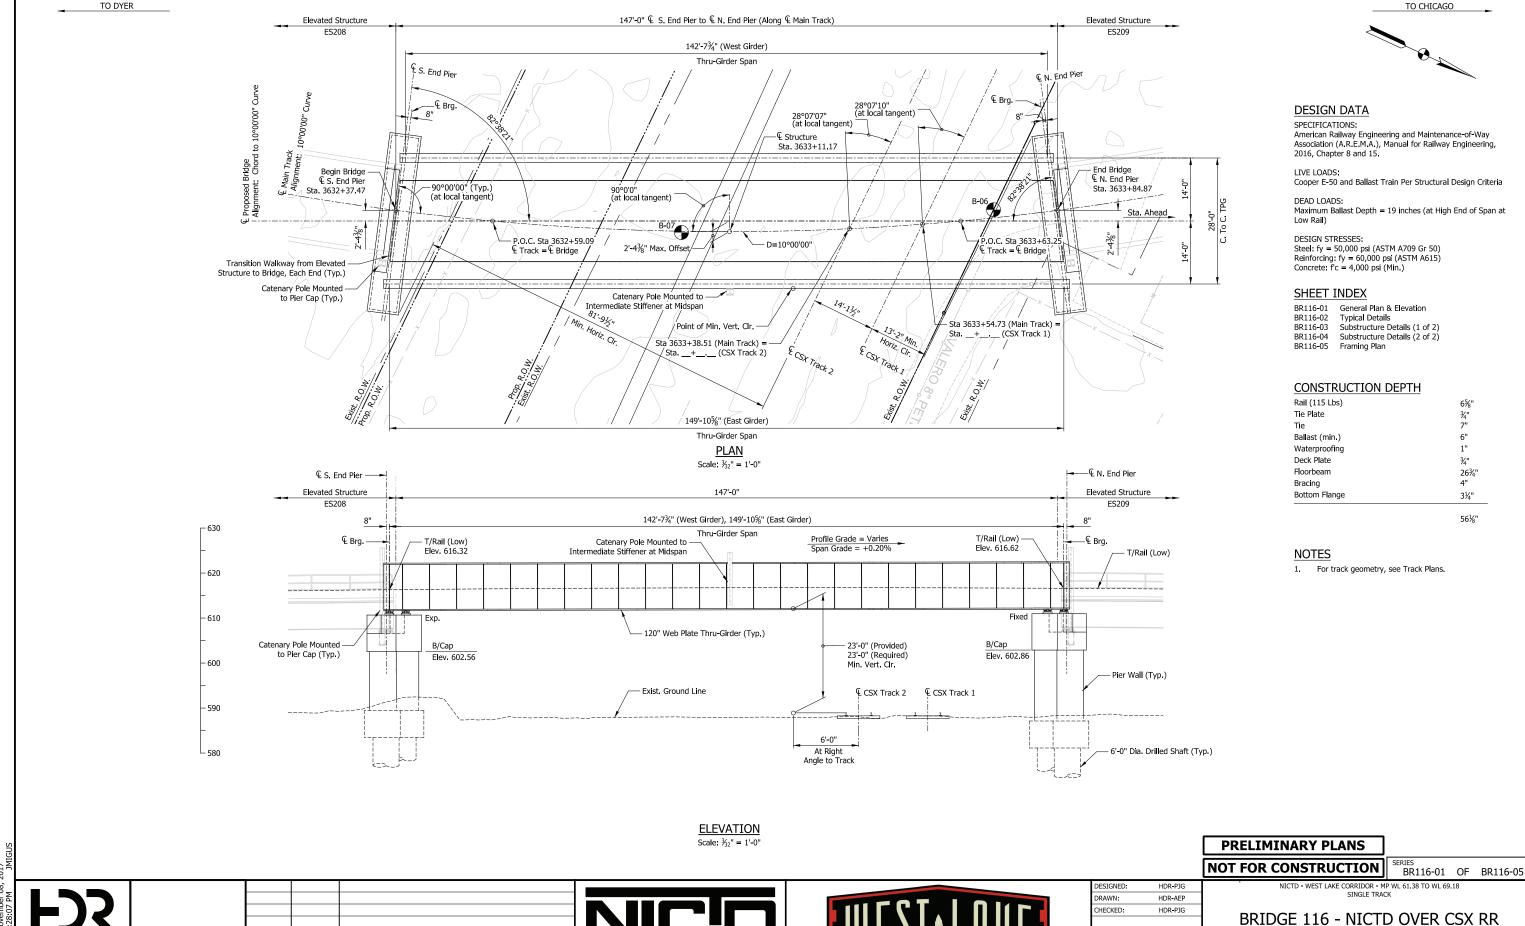


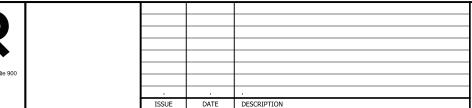



DESIGNED:	HDR-DTM		
DRAWN:	HDR-JSR		
CHECKED:	HDR-DTM		
DATE:	07/21/17		
		FILENAME	SH

	SCALE	AS NOTED	193 OF 218					
	FILENAME	SHT_WL_ST_ES208_FramPlan_03.dgn	SHEET AND OF 340					
	FRAMING PLAN (3 OF 3)							
7								
	1	ELEVATED STRU	JCTURE 208					
MT	1							
ISR	1	SINGLE TRAC	CK					
/1111	NICID - WEST EARE CORRIDOR - FIF WE 01:38 TO WE 05:18							



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NORTHERN INDIANA COMMUTER TRANSPORTATION DISTRICT 33 East Highway 12 Chesterton, Indiana 46304


DATE DESCRIPTION




DESIGNED:	HDR-PJG	
DRAWN:	HDR-AEP	
CHECKED:	HDR-PJG] ,
] t
DATE:	07/21/17	
		FILENAME

GENERAL PLAN & ELEVATION


SHT_WL_ST_BR116_GenPlan_01 194 OF 218 AS NOTED

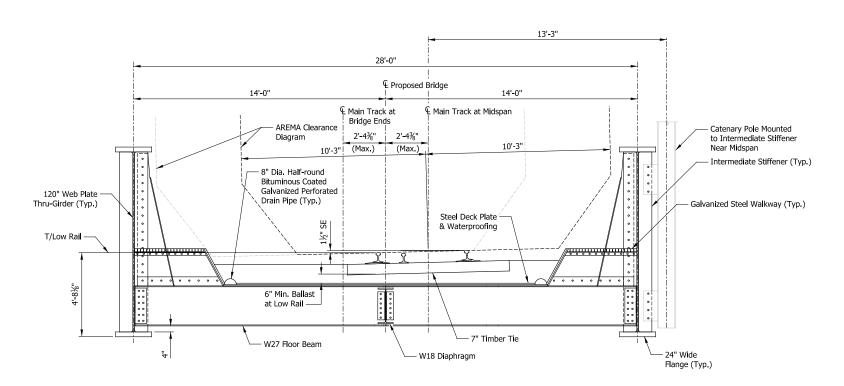

TYPICAL SECTION Scale: ¾" = 1'-0"

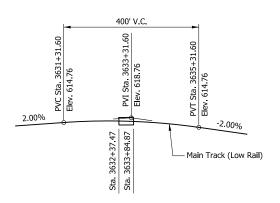

TOP OF RAIL PROFILE

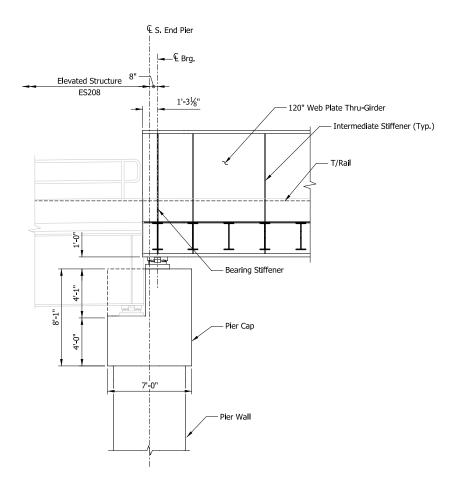

DESIGNED:

DRAWN: HECKED:

DATE:

HDR-AEP

SECTION THRU S. END PIER

Scale: ½" = 1'-0" (N. End Pier Similar)

PRELIMINARY PLANS

NOT FOR CONSTRUCTION

BR116-02 OF BR116-05


NICTD - WEST LAKE CORRIDOR - MP WL 61.38 TO WL 69.18 SINGLE TRACK


DATE DESCRIPTION








HDR-PJG BRIDGE 116 - NICTD OVER CSX RR 07/21/17 TYPICAL DETAILS FILENAME SHT_WL_ST_BR116_TypDet_01 195 OF 218 AS NOTED

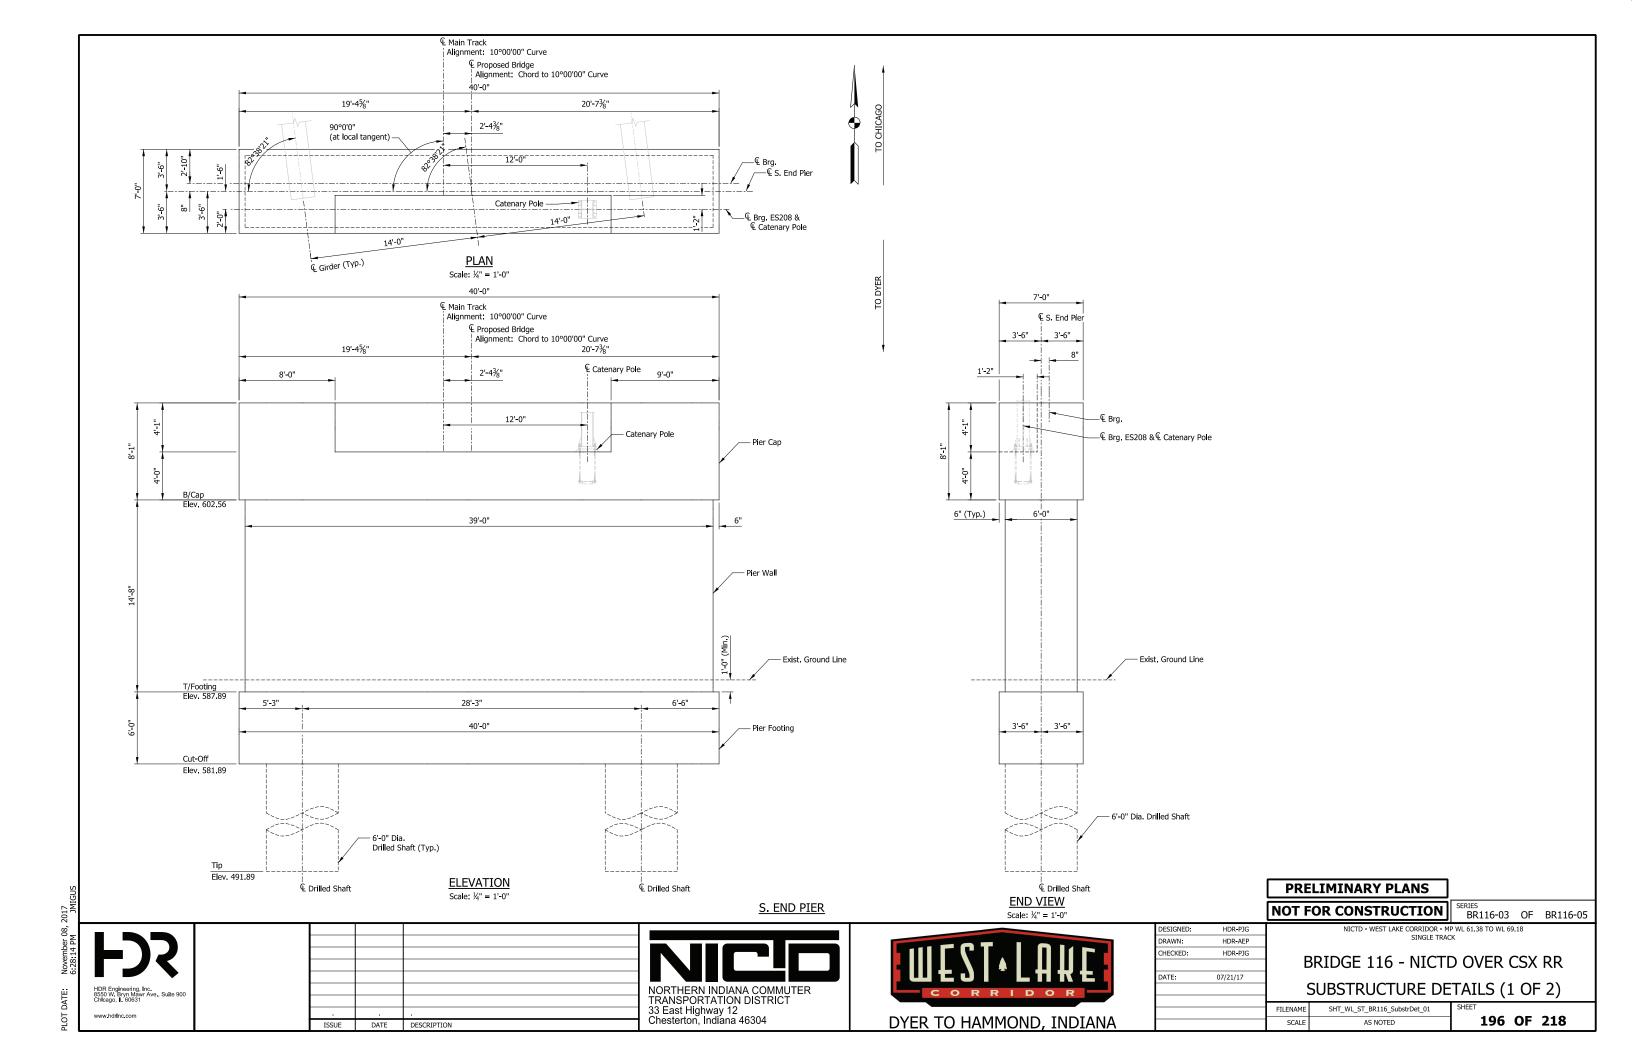

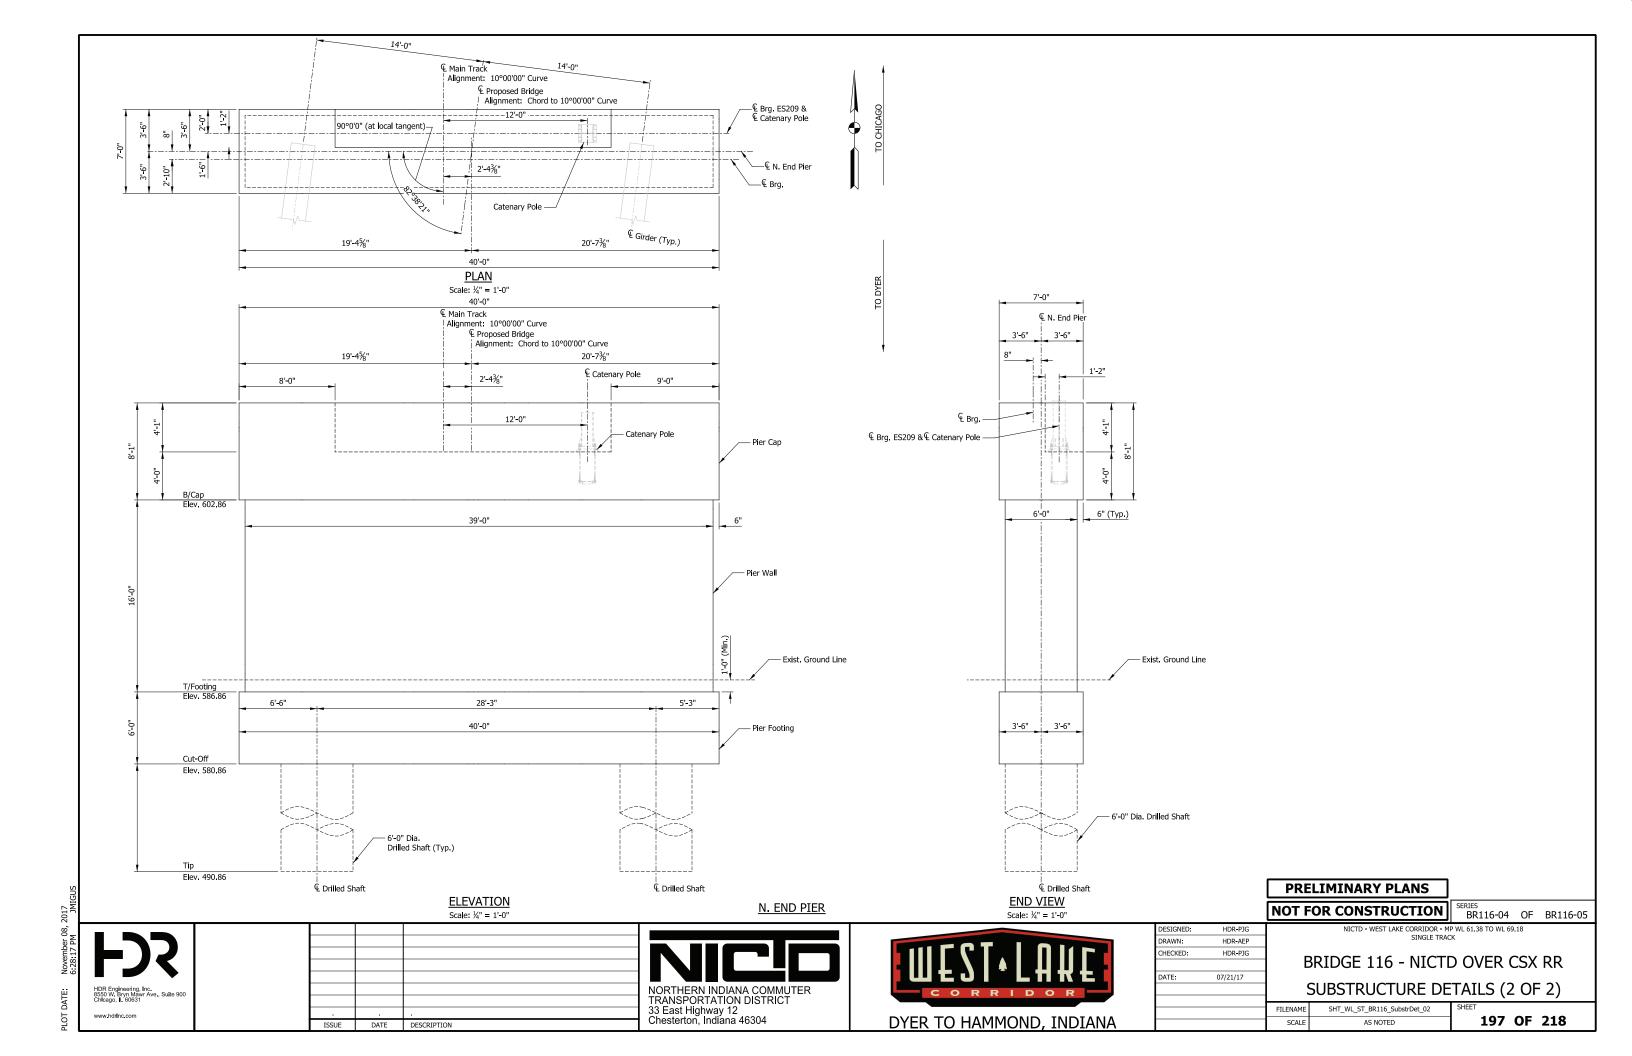

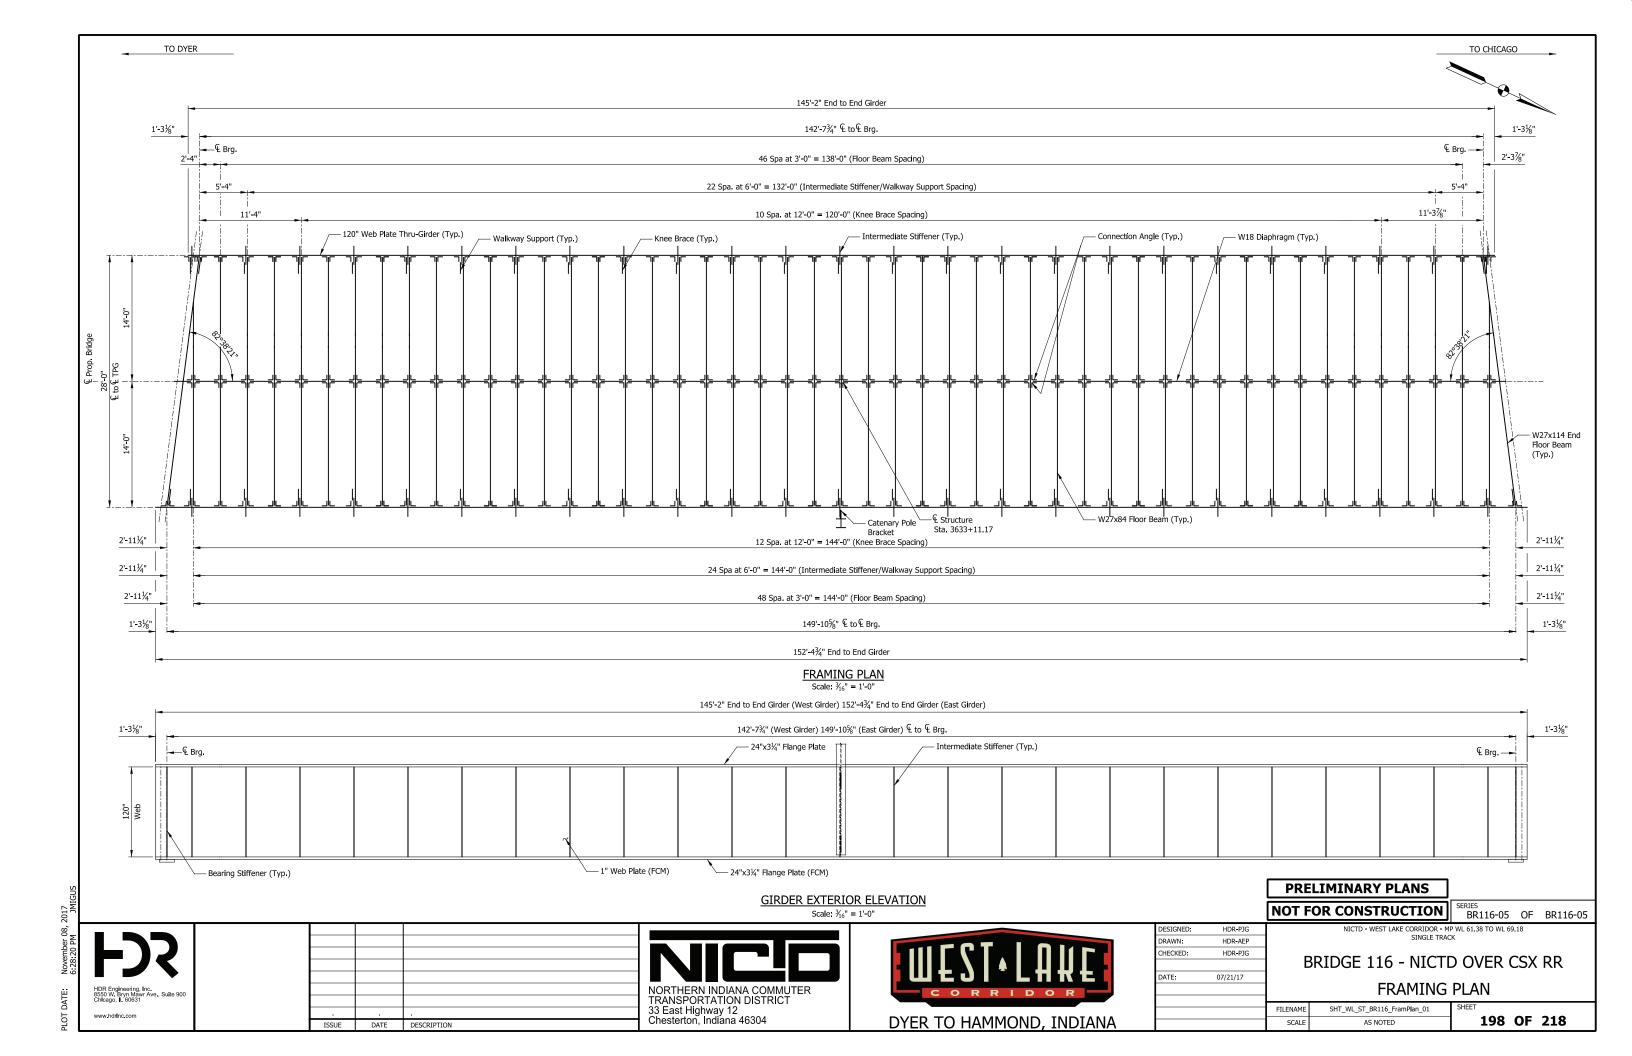

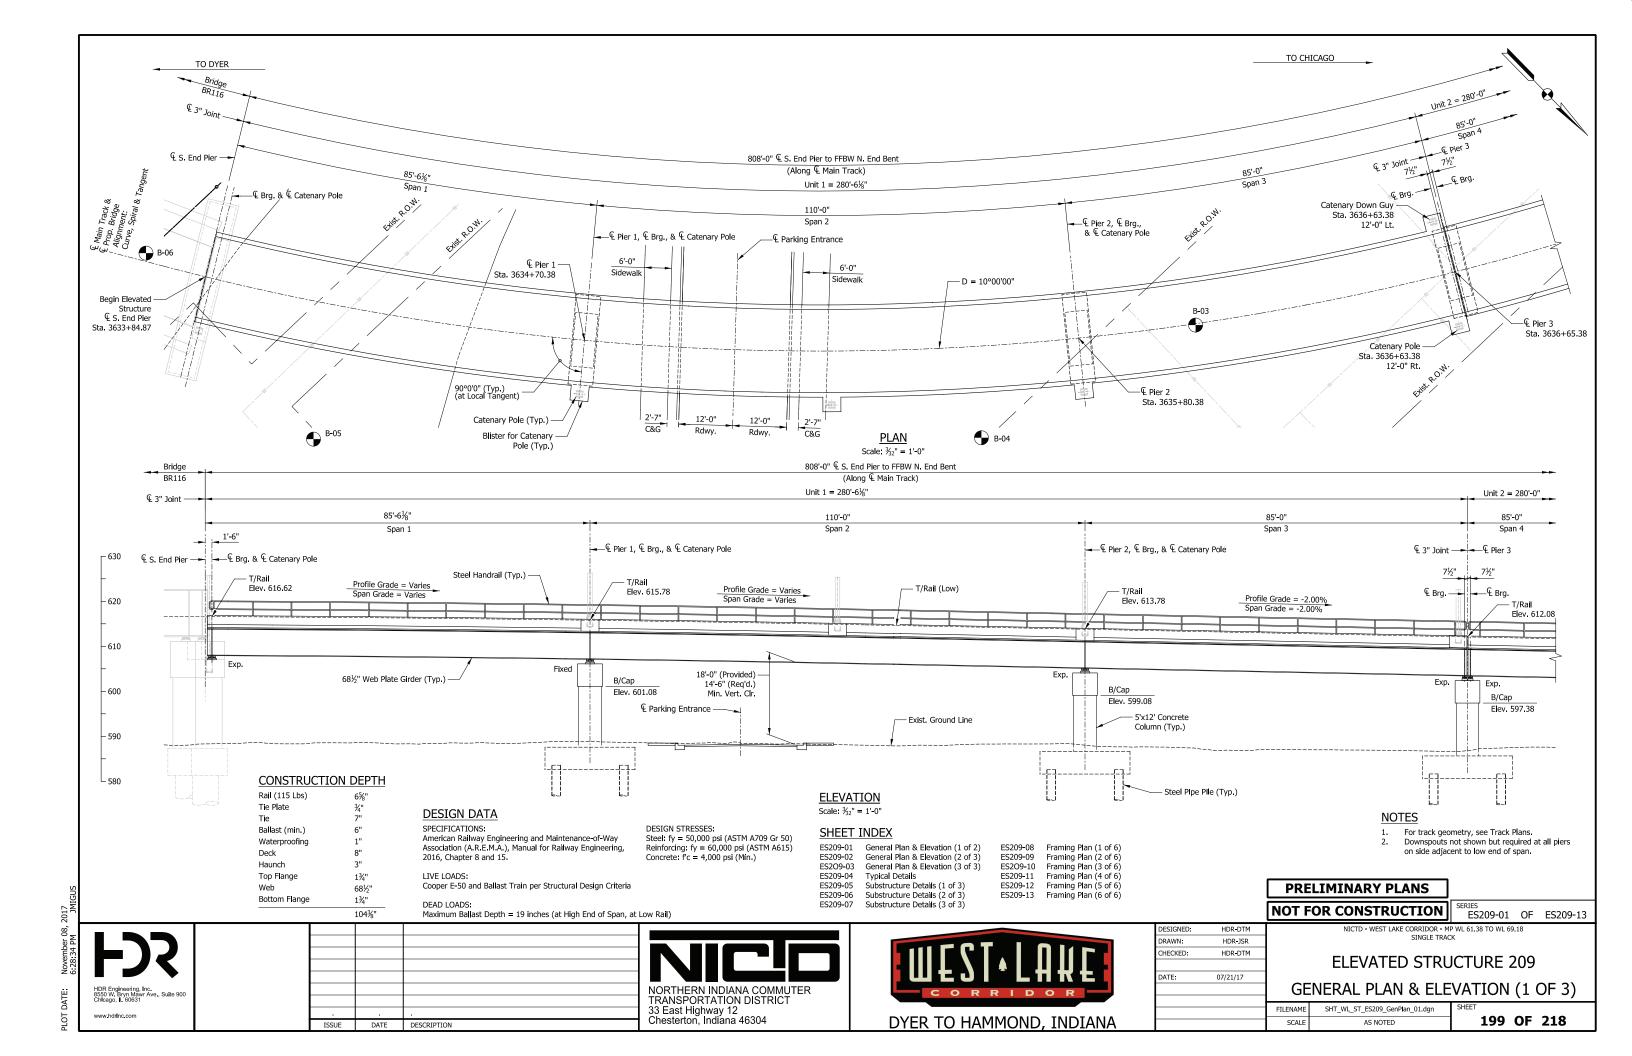

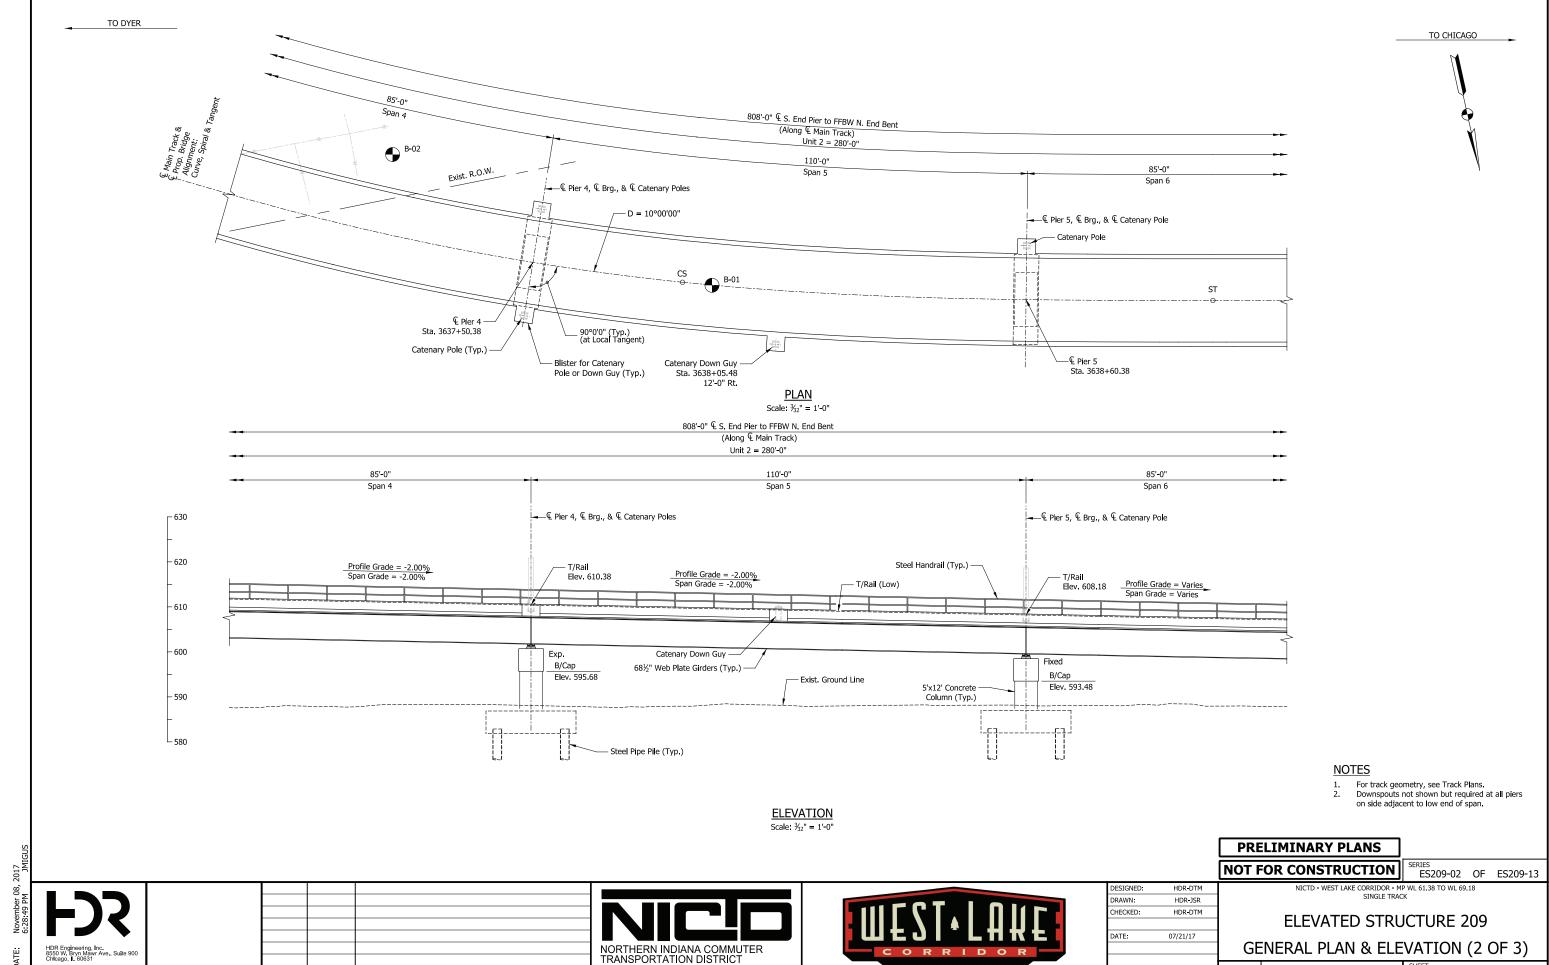

DYER TO HAMMOND, INDIANA

SHT_WL_ST_ES209_GenPlan_02.dgn


AS NOTED


200 OF 218


33 East Highway 12 Chesterton, Indiana 46304

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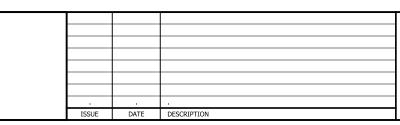
DATE DESCRIPTION



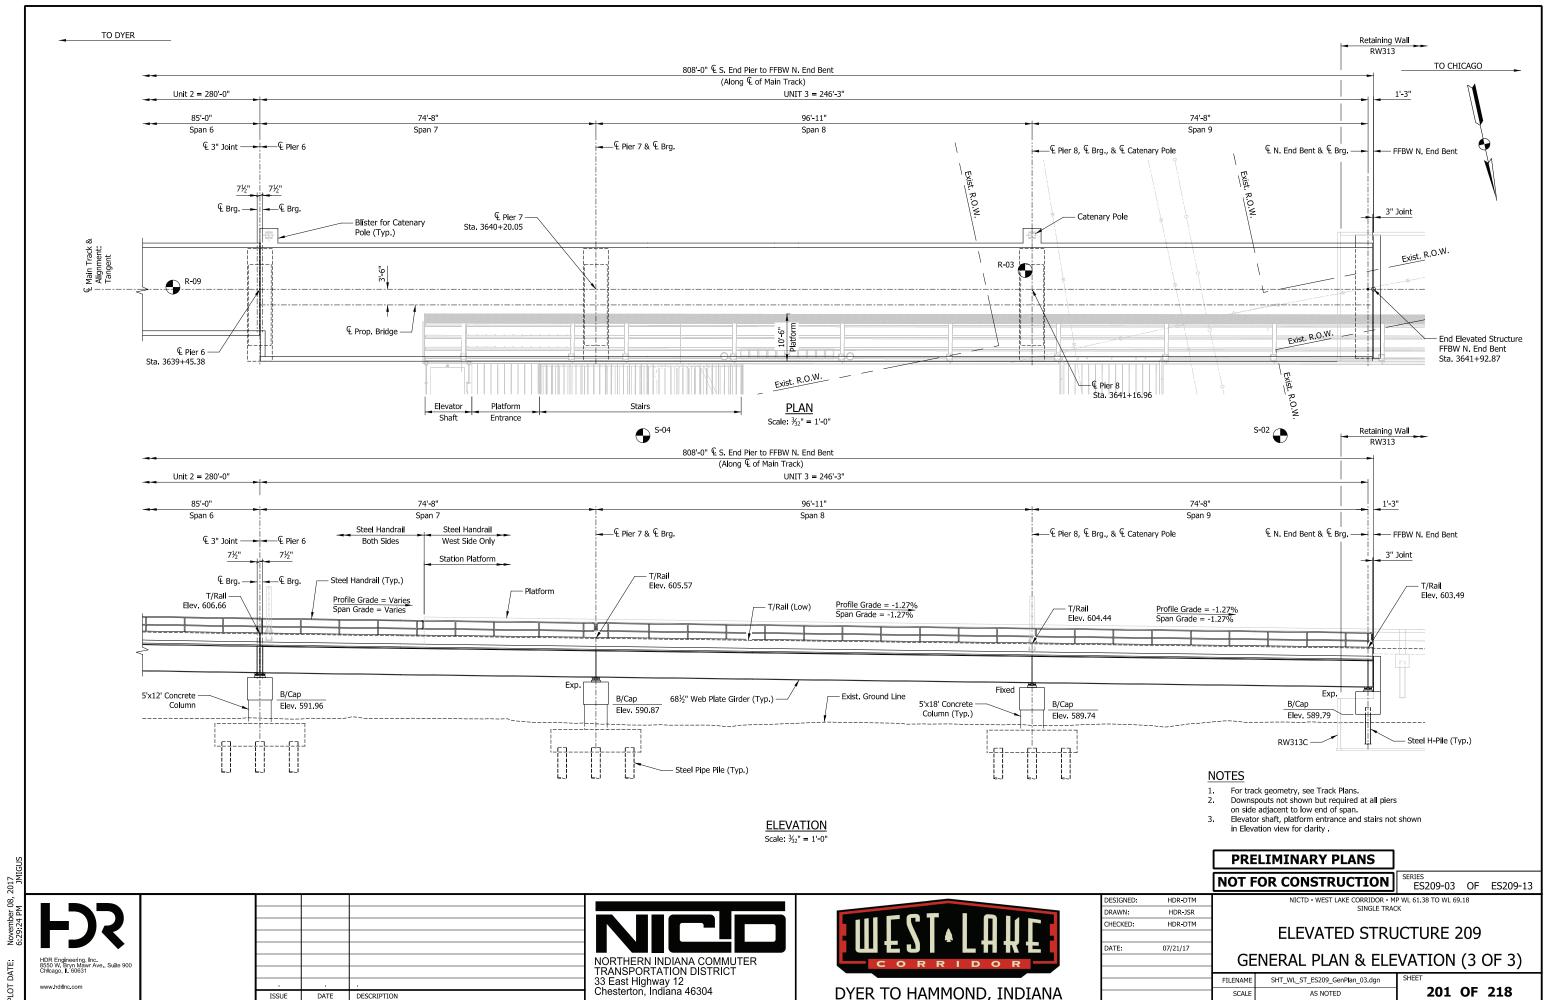

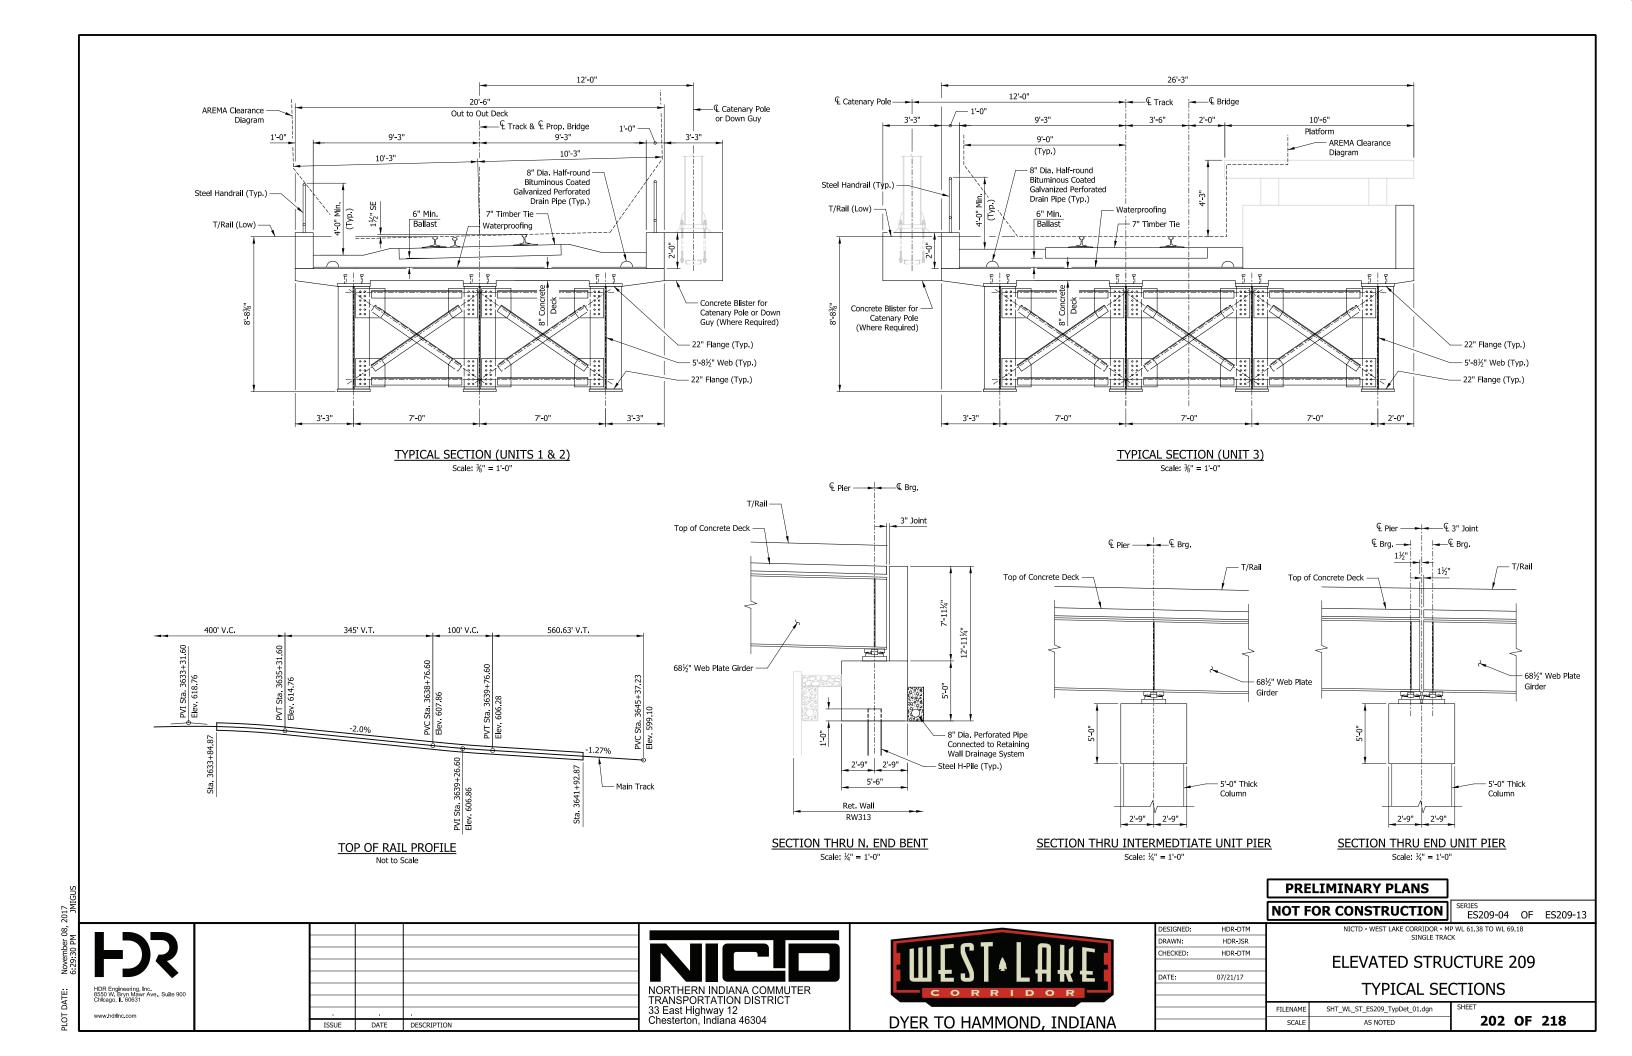
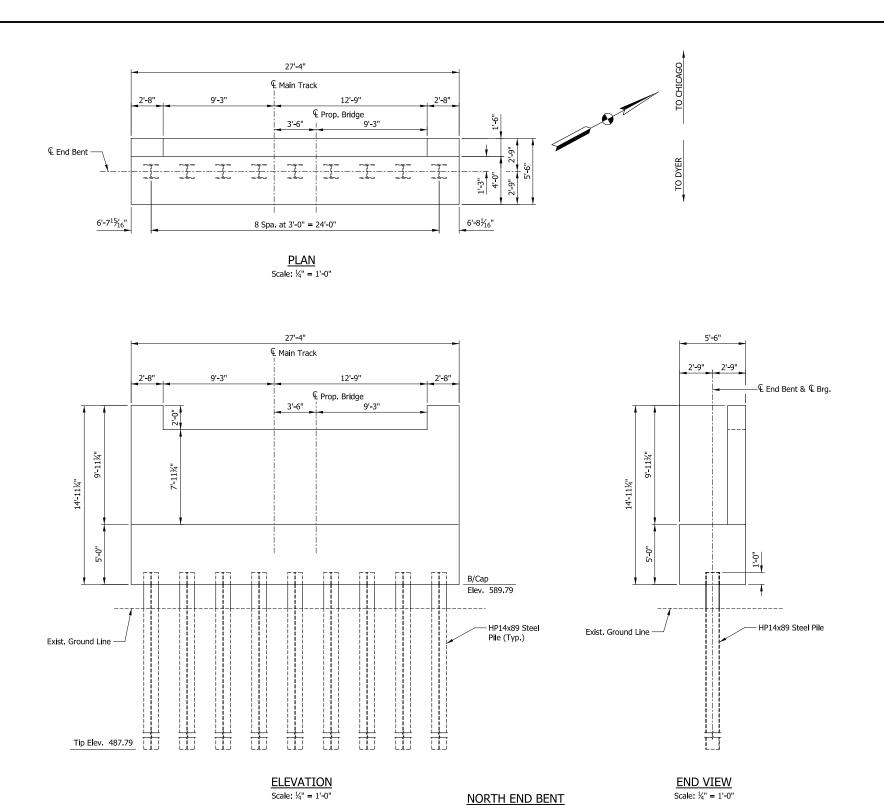
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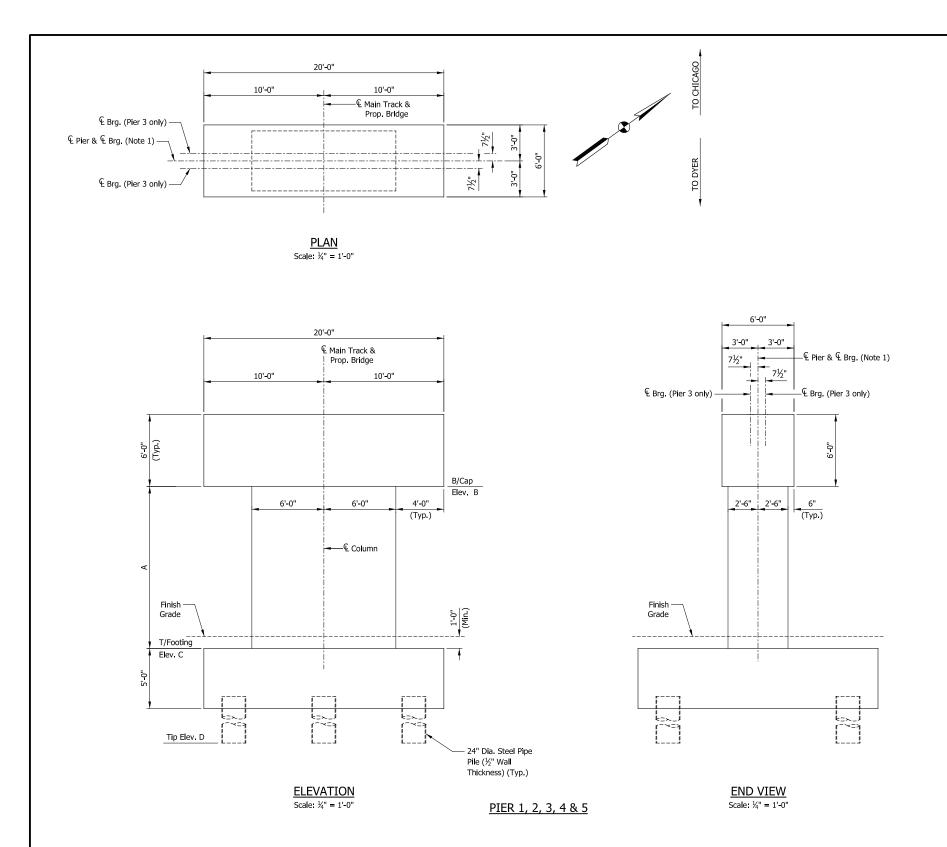





		NOT F	OR CONSTRUCTION	SERIES ES209-05	OF	ES209-13
DESIGNED:	HDR-DTM		NICTD - WEST LAKE CORRIDOR - M		.18	
DRAWN:	HDR-JSR		SINGLE TRAC	CK		
CHECKED:	HDR-DTM		ELEVATED CEDI	ICTUDE 3		
		ELEVATED STRUCTURE 209				
DATE:	07/21/17	1				
		SUBSTRUCTURE DETAILS (1 OF 3)				
		FILENAME	SHT_WL_ST_ES209_SubstrDet_01.dgn	SHEET		
		SCALE	AS NOTED	1 203	OF :	218

			L3207 03 OI L3207 13				
NED: HDR-DTM		NICTD - WEST LAKE CORRIDOR - MP WL 61.38 TO WL 69.18					
N: HDR-JSR	SINGLE TRACK						
ED: HDR-DTM		ELEVATED CTDL	ICTUDE 200				
	ELEVATED STRUCTURE 209						
07/21/17							
	SUBSTRUCTURE DETAILS (1 OF 3)						
			(
	FILENAME	SHT_WL_ST_ES209_SubstrDet_01.dgn	SHEET				
	SCALE	AS NOTED	203 OF 218				

PRELIMINARY PLANS



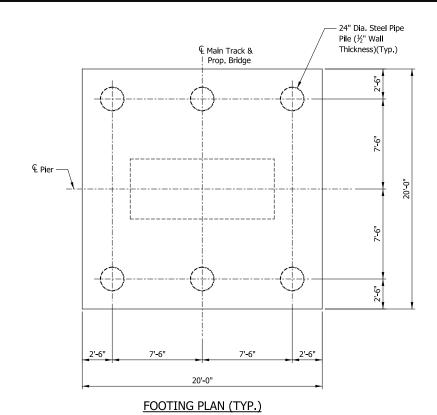

GEOMETRY TABLE					
LOCATION	Dim, A	Elev. B	Elev. C	Elev. D	
Pier 1	13'-6"	601.08	587.58	484.58	
Pier 2	12'-6"	599.08	586.58	483.58	
Pier 3	11'-9"	597.38	585.63	482.63	
Pier 4	8'-10"	595.68	586.85	483.85	
Pier 5	6'-6"	593.48	586.98	483.98	

NOTES

1. \P Pier = \P Bearing on all piers except Pier 3.

PRELIMINARY PLANS

ES209-06 OF ES209-13 NOT FOR CONSTRUCTION

DESIGNED:

HDR-JSR HDR-DTM

07/21/17

DRAWN:

HECKED:


DATE:

NICTD - WEST LAKE CORRIDOR - MP WL 61.38 TO WL 69.18 SINGLE TRACK **ELEVATED STRUCTURE 209**

SUBSTRUCTURE DETAILS (2 OF 3)


SHT_WL_ST_ES209_SubstrDet_02.dgn AS NOTED


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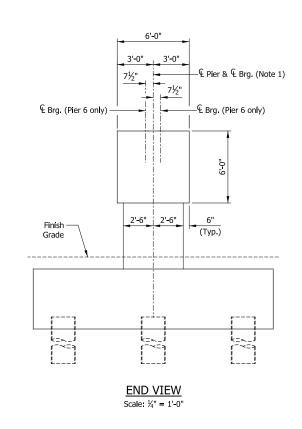


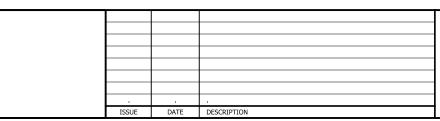






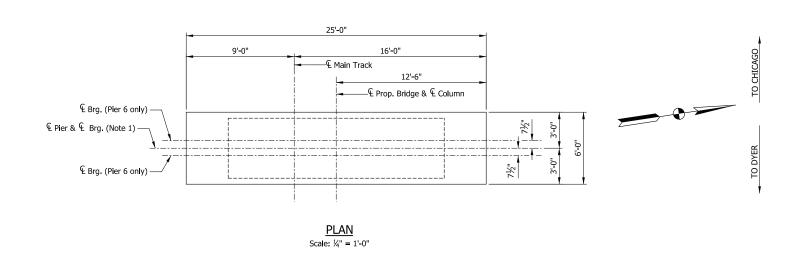

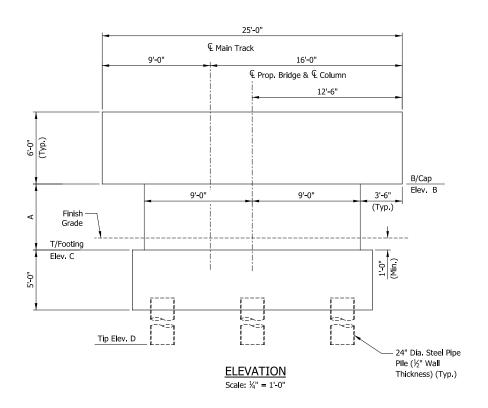

PIER 6, 7 & 8

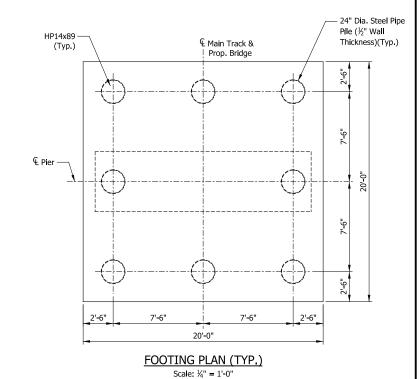

GEOMETRY TABLE				
LOCATION	Dim, A	Elev. B	Elev. C	Elev. D
Pier 6	5'-3"	591.96	586.71	483.71
Pier 7	5'-7"	590.87	585.29	482.29
Pier 8	4'-5"	589 74	585 32	482 32

NOTES

1. Fier = & Bearing on all piers except Pier 6.

PRELIMINARY PLANS NOT FOR CONSTRUCTION

ES209-07 OF ES209-13

NICTD - WEST LAKE CORRIDOR - MP WL 61.38 TO WL 69.18 SINGLE TRACK

ELEVATED STRUCTURE 209 SUBSTRUCTURE DETAILS (3 OF 3)

SHT_WL_ST_ES209_SubstrDet_03.dgn 205 OF 218 AS NOTED

トノン				
HDR Engineering, Inc. 9550 W. Bryn Mawr Ave., Suite 900 Chtago, U. 60631				
www.hdrinc.com	ISSUE	DATE	DESCRIPTION	





DESIGNED:

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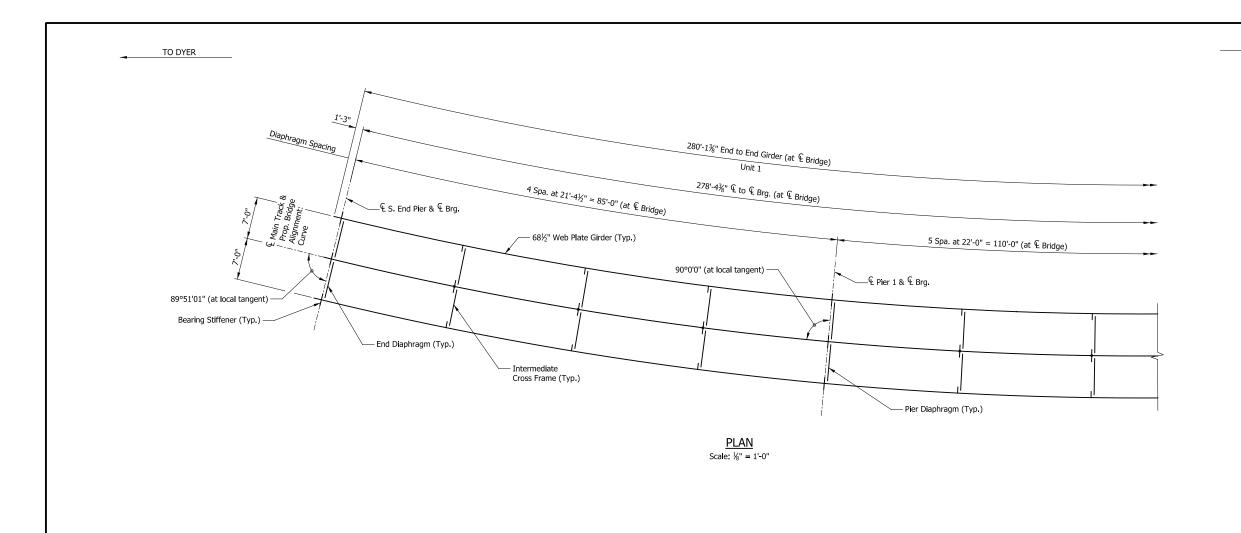
HECKED:

DATE:

HDR-DTM

HDR-JSR HDR-DTM

07/21/17



280'-1%" End to End Girder (at \P Bridge) 278'-4¾" & to & Brg. (at & Bridge) 1'-3" ——& S. End Pier & & Brg. – 22"x1¾" Flange Plate ——€ Pier 1 & € Brg. — Bearing Stiffener (Typ.) -¾" Web Plate — 22"x1¾" Flange Plate

> **ELEVATION** Scale: ½" = 1'-0"

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		NOT F	OR CONSTRUCTION
DESIGNED:	HDR-JAL		NICTD - WEST LAKE CORRIDOR - MP
DRAWN:	HDR-JSR	SIN	
CHECKED:	HDR-JAL		ELEVATED CEDIL
			ELEVATED STRU
DATE:	07/21/17		
		1	FRAMING PLAN
		FILENAME	SHT_WL_ST_ES209_FramPlan_01.dgn


TO CHICAGO

	NICTD - WEST LAKE CORRIDOR - MI SINGLE TRAC					
	ELEVATED STRUCTURE 209					
	FRAMING PLAN (1 OF 6)					
AME	SHT_WL_ST_ES209_FramPlan_01.dgn	SHEET				

PRELIMINARY PLANS

SCALE

206 OF 218 AS NOTED

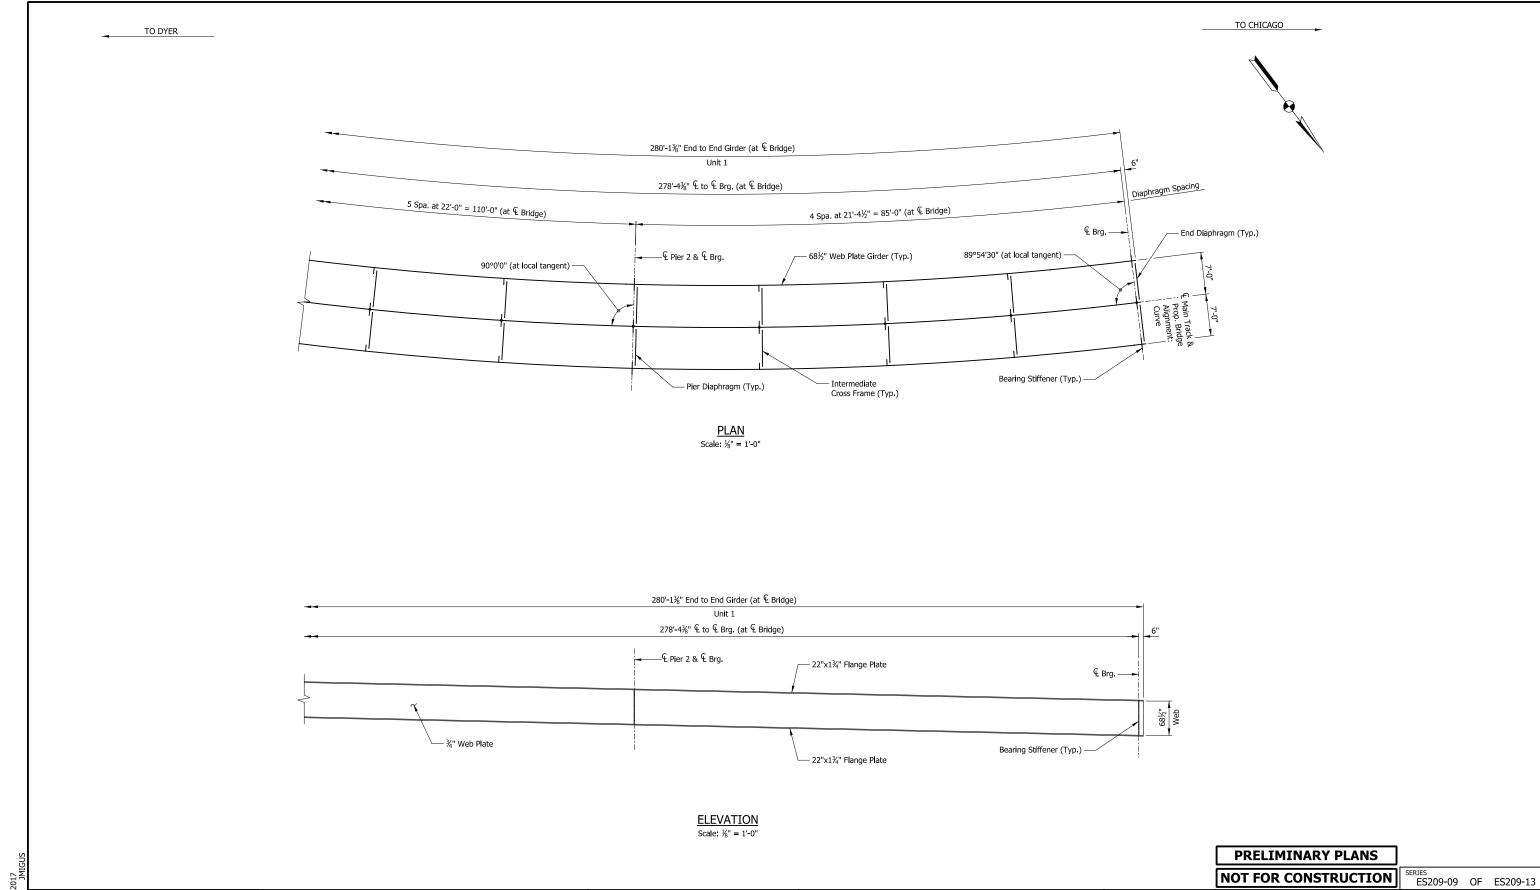


www.hdrinc.com ISSUE DATE DESCRIPTION NORTHERN INDIANA COMMUTER TRANSPORTATION DISTRICT 33 East Highway 12 Chesterton, Indiana 46304




NICTD - WEST LAKE		HDR-JAL	DESIGNED:
		HDR-JSR	DRAWN:
		HDR-JAL	CHECKED:
ELEVATE			
		07/21/17	DATE:
FRAMIN			
SHT WL ST ES209 FramF	FILENAME		

NICTD - WEST LAKE CORRIDOR - MP WL 61.38 TO WL 69.18 SINGLE TRACK					
ELEVATED STRUCTURE 209					
FRAMING PLAN (2 OF 6)					
FILENAME	SHT_WL_ST_ES209_FramPlan_02.dgn	SHEET			
SCALE	AS NOTED	1 207 OF 218			

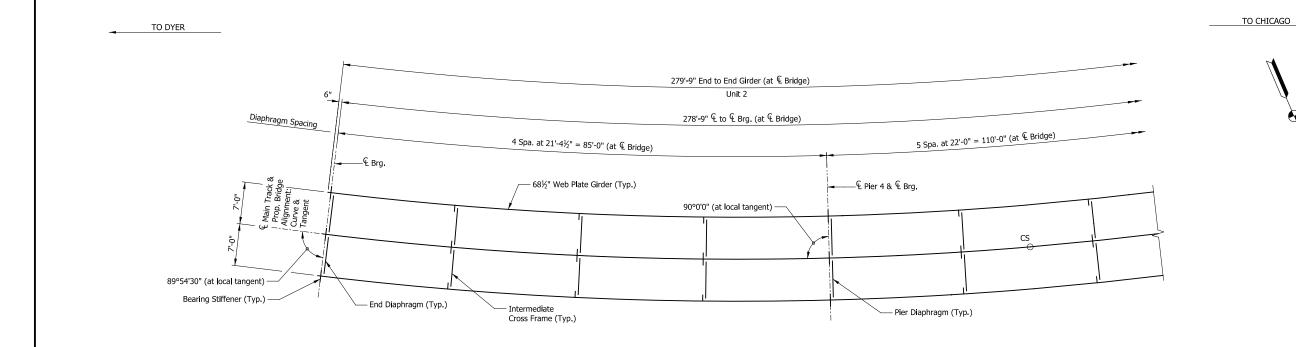

<u>PLAN</u> Scale: 1/8" = 1'-0"

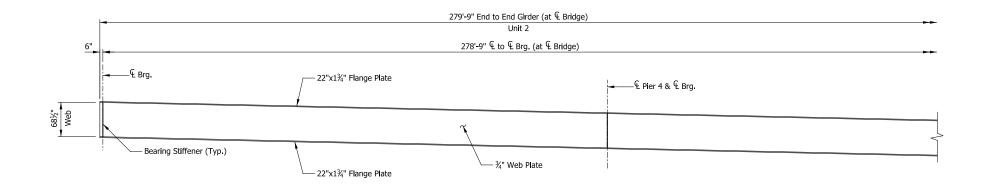

ELEVATION Scale: 1/-0"

> PRELIMINARY PLANS NOT FOR CONSTRUCTION

> > AS NOTED

ES209-10 OF ES209-13

208 OF 218

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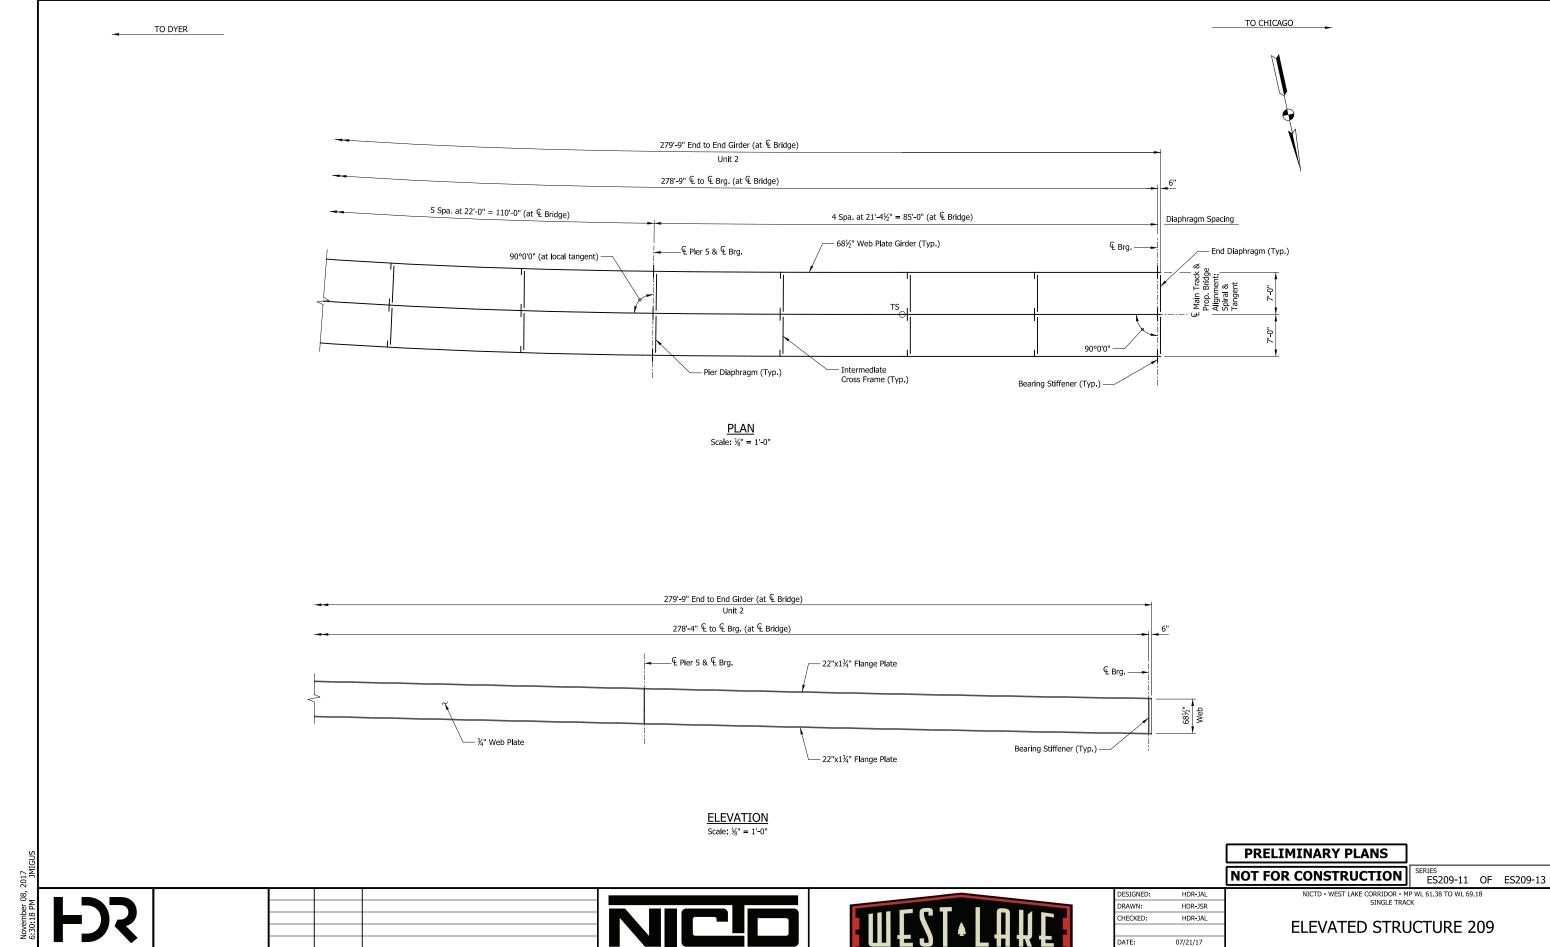
ISSUE DATE DESCRIPTION

NORTHERN INDIANA COMMUTER TRANSPORTATION DISTRICT 33 East Highway 12 Chesterton, Indiana 46304



DESIGNED:	HDR-JAL		
DRAWN:	HDR-JSR		
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DATE:	07/21/17		
		—	_
		FILENAME	

ELEVATED STRUCTURE 209 FRAMING PLAN (3 OF 6) SHT_WL_ST_ES209_FramPlan_03.dgn



NORTHERN INDIANA COMMUTER TRANSPORTATION DISTRICT 33 East Highway 12 Chesterton, Indiana 46304

DYER TO HAMMOND, INDIANA

FRAMING PLAN (4 OF 6)

209 OF 218


SHT_WL_ST_ES209_FramPlan_04.dgn

AS NOTED

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DATE DESCRIPTION

TO CHICAGO TO DYER

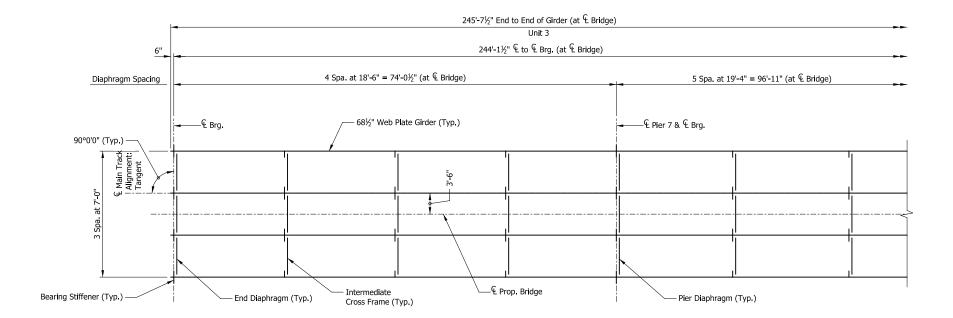

245'-7½" End to End Girder (at € Bridge) Unit 3 244'-1½" & to & Brg. (at & Bridge) — 22"x1¾" Flange Plate ₽ Brg. ₽ Pier 7 & ₽ Brg. - Bearing Stiffener (Typ.) - 22"x1¾" Flange Plate

<u>PLAN</u> Scale: ½" = 1'-0"

ELEVATION Scale: ½" = 1'-0"

PRELIMINARY PLANS

NOT FOR CONSTRUCTION

DESIGNED: DRAWN:

CHECKED:

DATE:

HDR-JSR

HDR-JAL


07/21/17

ES209-12 OF ES209-13

ELEVATED STRUCTURE 209 FRAMING PLAN (5 OF 6)

FILENAME SHT_WL_ST_ES209_FramPlan_05.dgn 210 OF 218 AS NOTED


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DYER TO HAMMOND, INDIANA

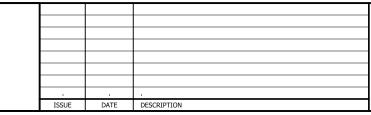

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ISSUE DATE DESCRIPTION


NORTHERN INDIANA COMMUTER TRANSPORTATION DISTRICT 33 East Highway 12 Chesterton, Indiana 46304

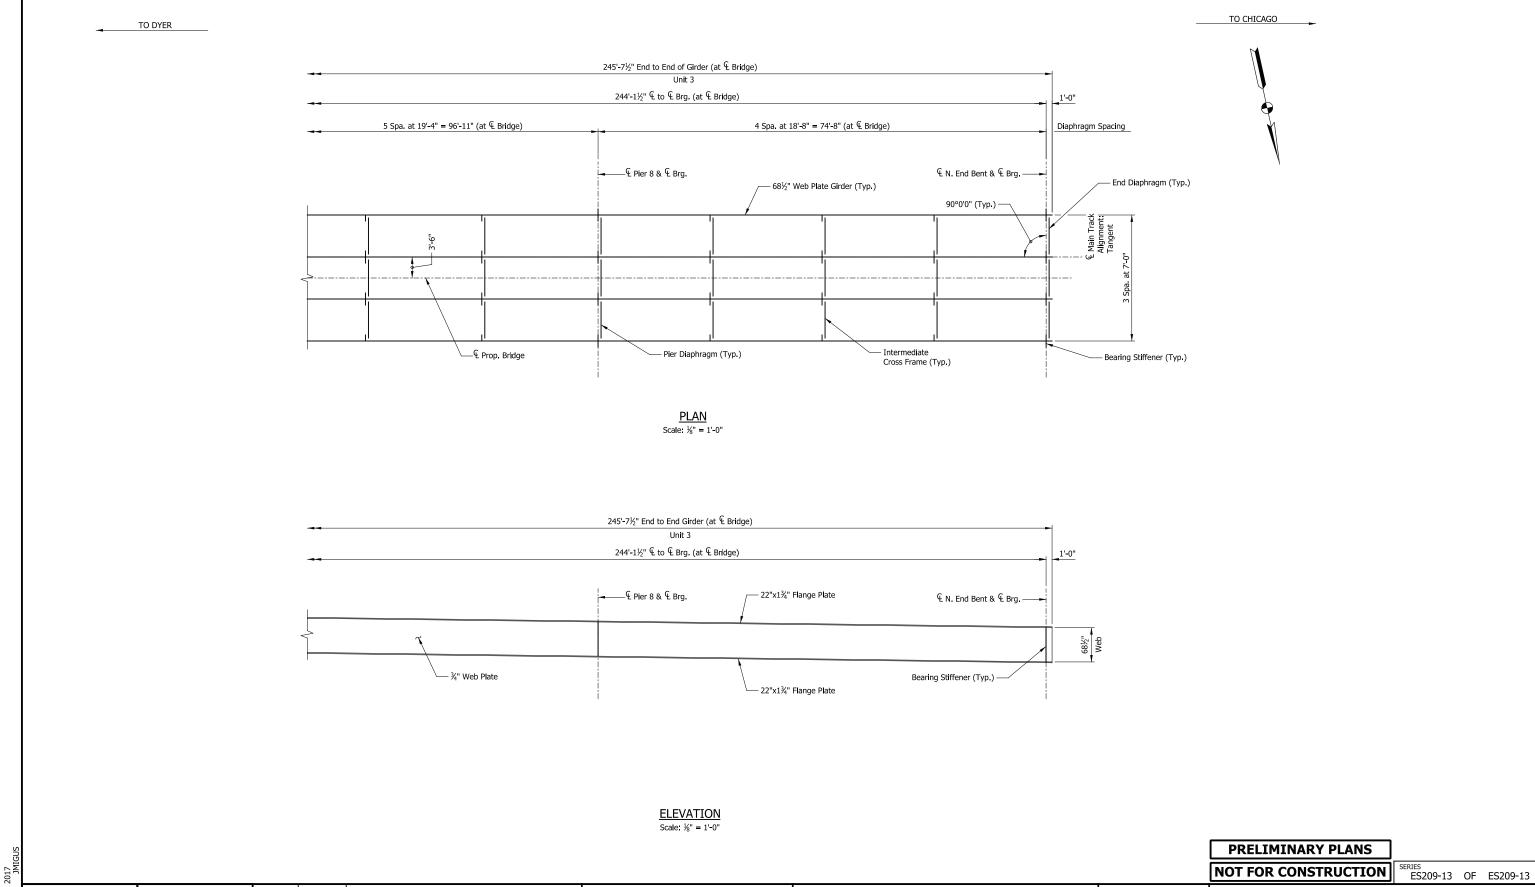



DESIGNED:	HDR-JAL	
DRAWN:	HDR-JSR	
CHECKED:	HDR-JAL	
DATE:	07/21/17	
		FILE

ELEVATED STRUCTURE 209 FRAMING PLAN (6 OF 6)


SHT_WL_ST_ES209_FramPlan_06.dgn 211 OF 218 AS NOTED

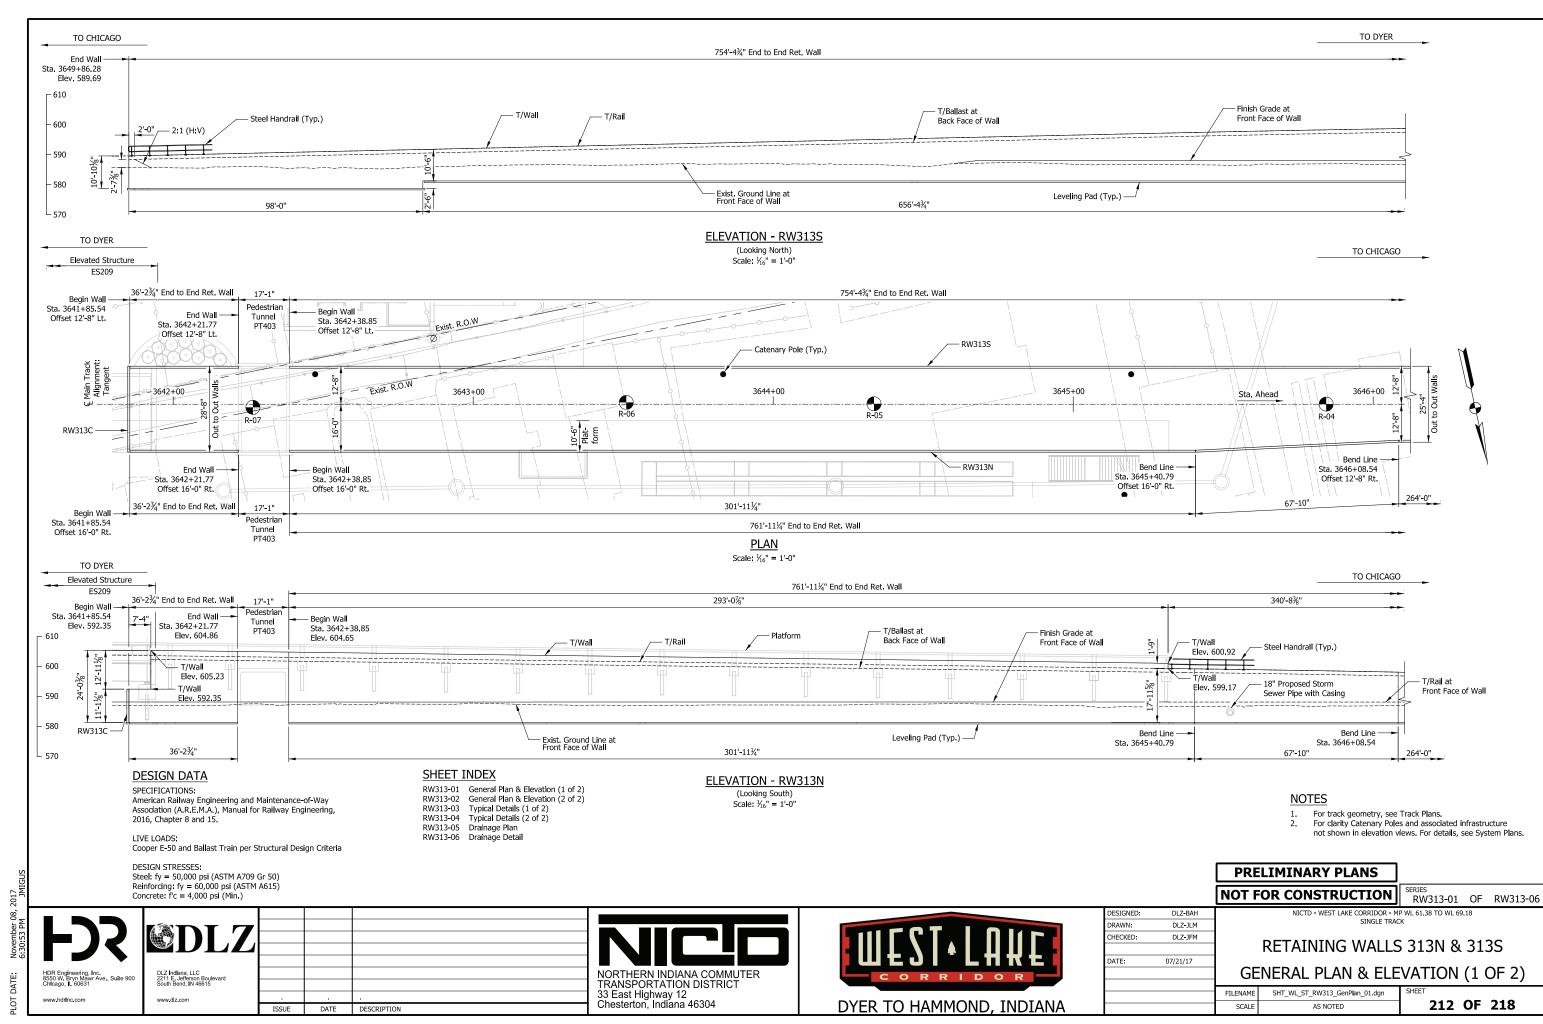


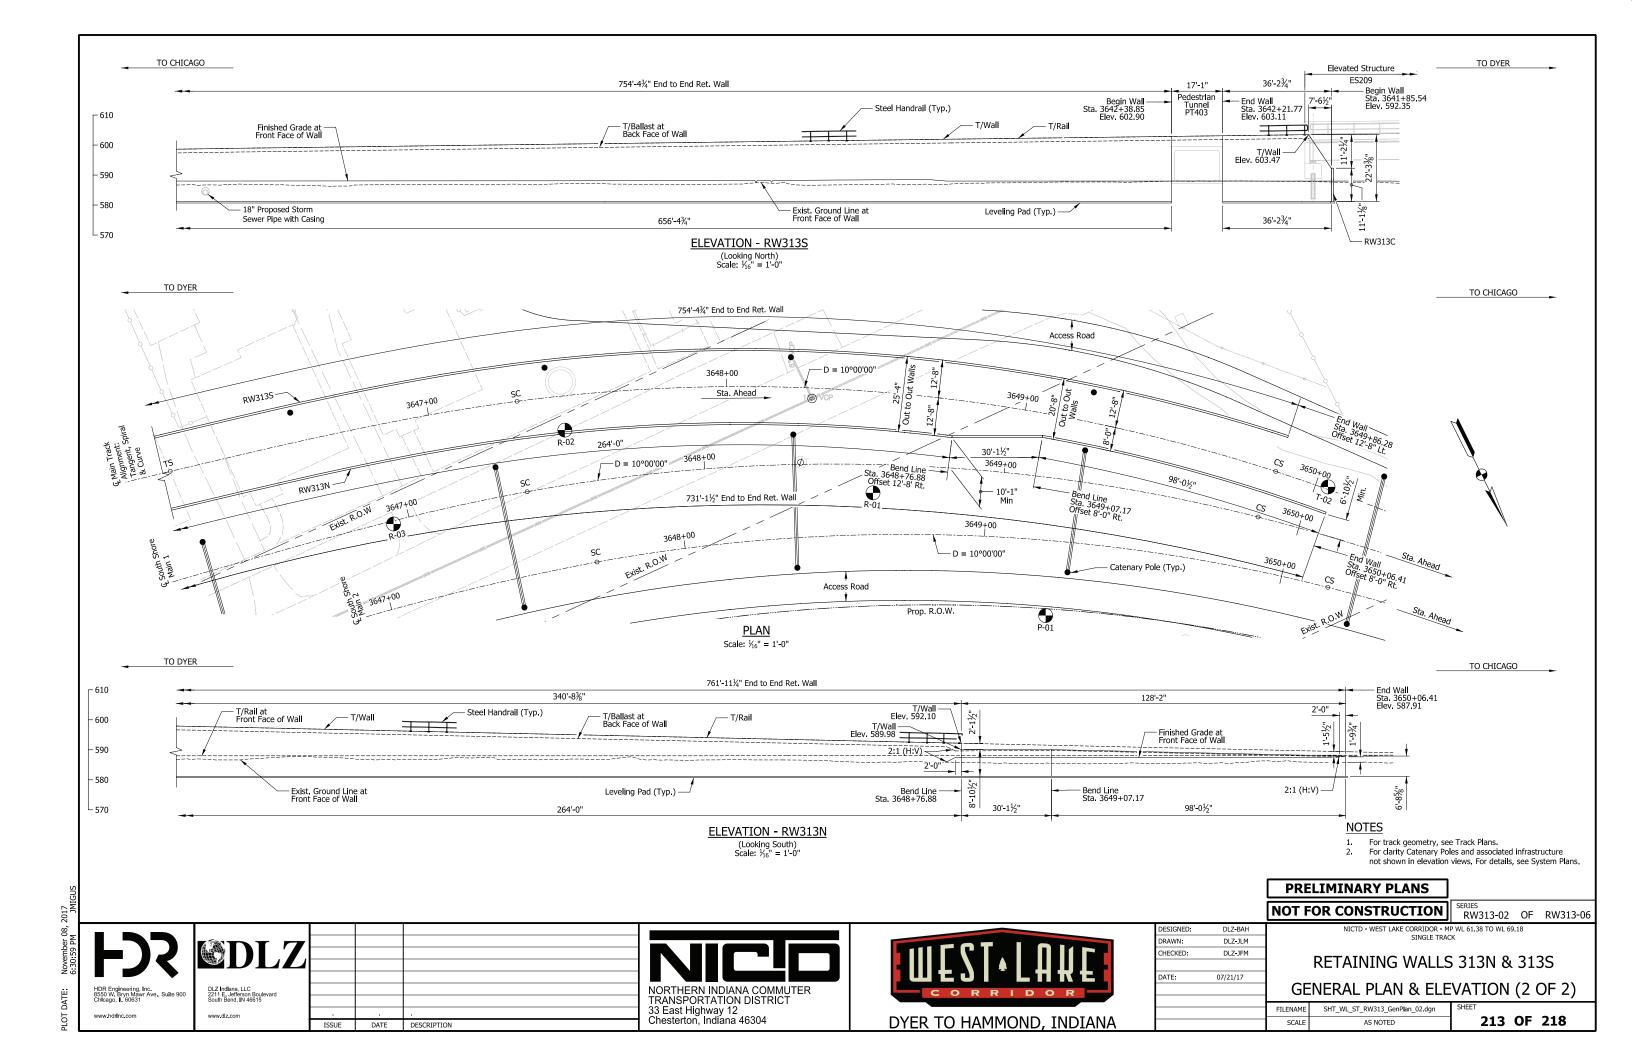

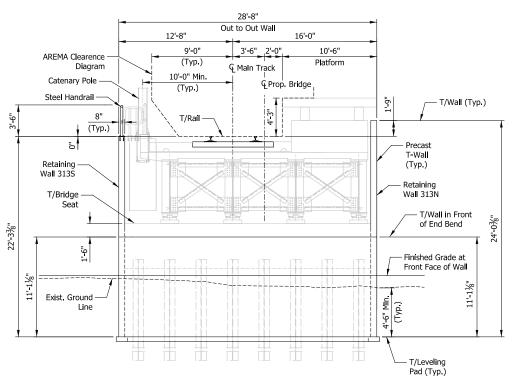


ELEVATION - RET. WALL 313C (Looking Upstation)

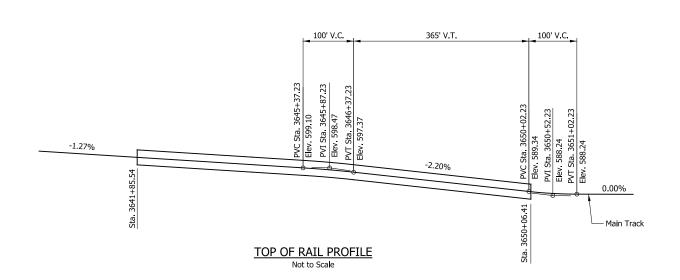

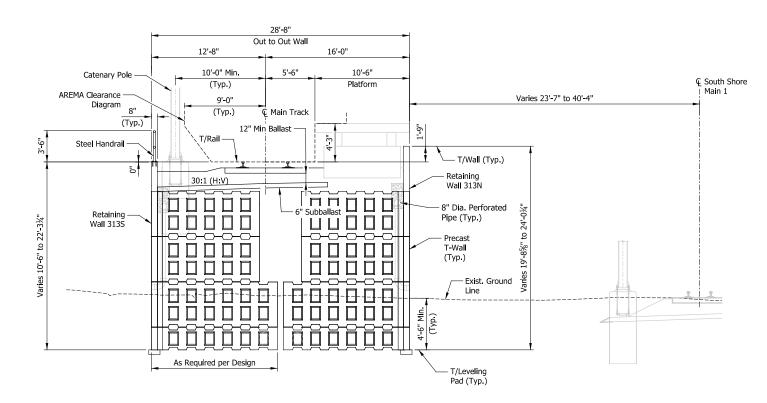

TYPICAL SECTION AT PLATFORM

(Looking Upstation) Scale: $\frac{3}{16}$ " = 1'-0"

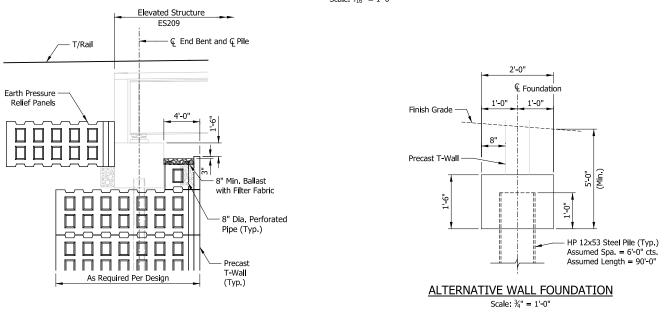

DATE DESCRIPTION

DLZ Indiana, LLC 2211 E. Jefferson Boulevard South Bend, IN 46615

www.dlz.com

NORTHERN INDIANA COMMUTER TRANSPORTATION DISTRICT 33 East Highway 12 Chesterton, Indiana 46304



SECTION THRU END BENT

		NOT F	OR CONSTRUCTION	
DESIGNED:	DLZ-BAH			
DRAWN:	DLZ-JLM		SINGLE TRACK	
CHECKED:	DLZ-JFM	RETAINING WALLS		
)
DATE:	07/21/17			
		TYPICAL DETAIL		L
		FILENAME	SHT_WL_ST_RW313_TypDet_01.dgn	Г
	DRAWN: CHECKED:	DRAWN: DLZ-JLM CHECKED: DLZ-JFM	DESIGNED: DLZ-BAH DRAWN: DLZ-JLM CHECKED: DLZ-JFM DATE: 07/21/17	DRAWN: DLZ-JLM CHECKED: DLZ-JFM DATE: 07/21/17 TYPICAL DETAI

SCALE


SINGLE TRACK	
RETAINING WALLS 313N & 313S	
TYPICAL DETAILS (1 OF 2)	

PRELIMINARY PLANS

SHT_WL_ST_RW313_TypDet_01.dgn 214 OF 218 AS NOTED


RW313-03 OF RW313-06

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TYPICAL SECTION WITH HANDRAILS BOTH SIDES

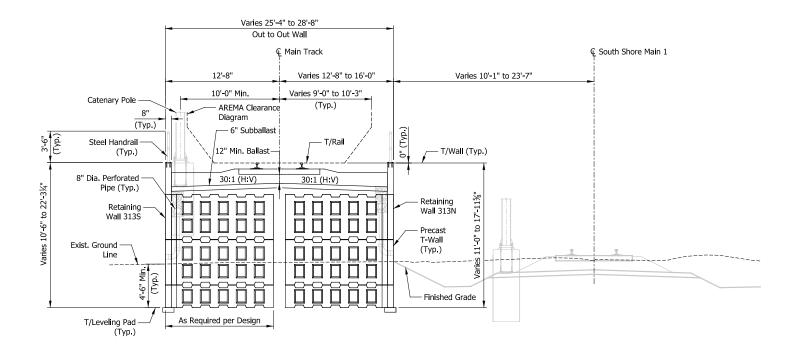(Looking Upstation) Scale: $\frac{3}{16}$ " = 1'-0"



TYPICAL SECTION WITH HANDRAIL ONE SIDE

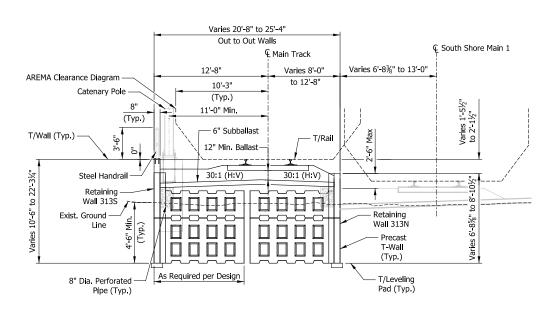(Looking Upstation) Scale: $\frac{3}{16}$ " = 1'-0"

PRELIMINARY PLANS

NOT FOR CONSTRUCTION

DLZ-BAH

DLZ-JLM

DLZ-JFM

07/21/17

DRAWN:

DATE:

HECKED:

RW313-04 OF RW313-06

NICTD - WEST LAKE CORRIDOR - MP WL 61.38 TO WL 69.18 SINGLE TRACK

RETAINING WALLS 313N & 313S

TYPICAL DETAILS (2 OF 2)

HDR Engineering, Inc.
8550 W. Bryn Mawr Ave., Suite 900
Chtago, IL Bodul Bend, IN 46015

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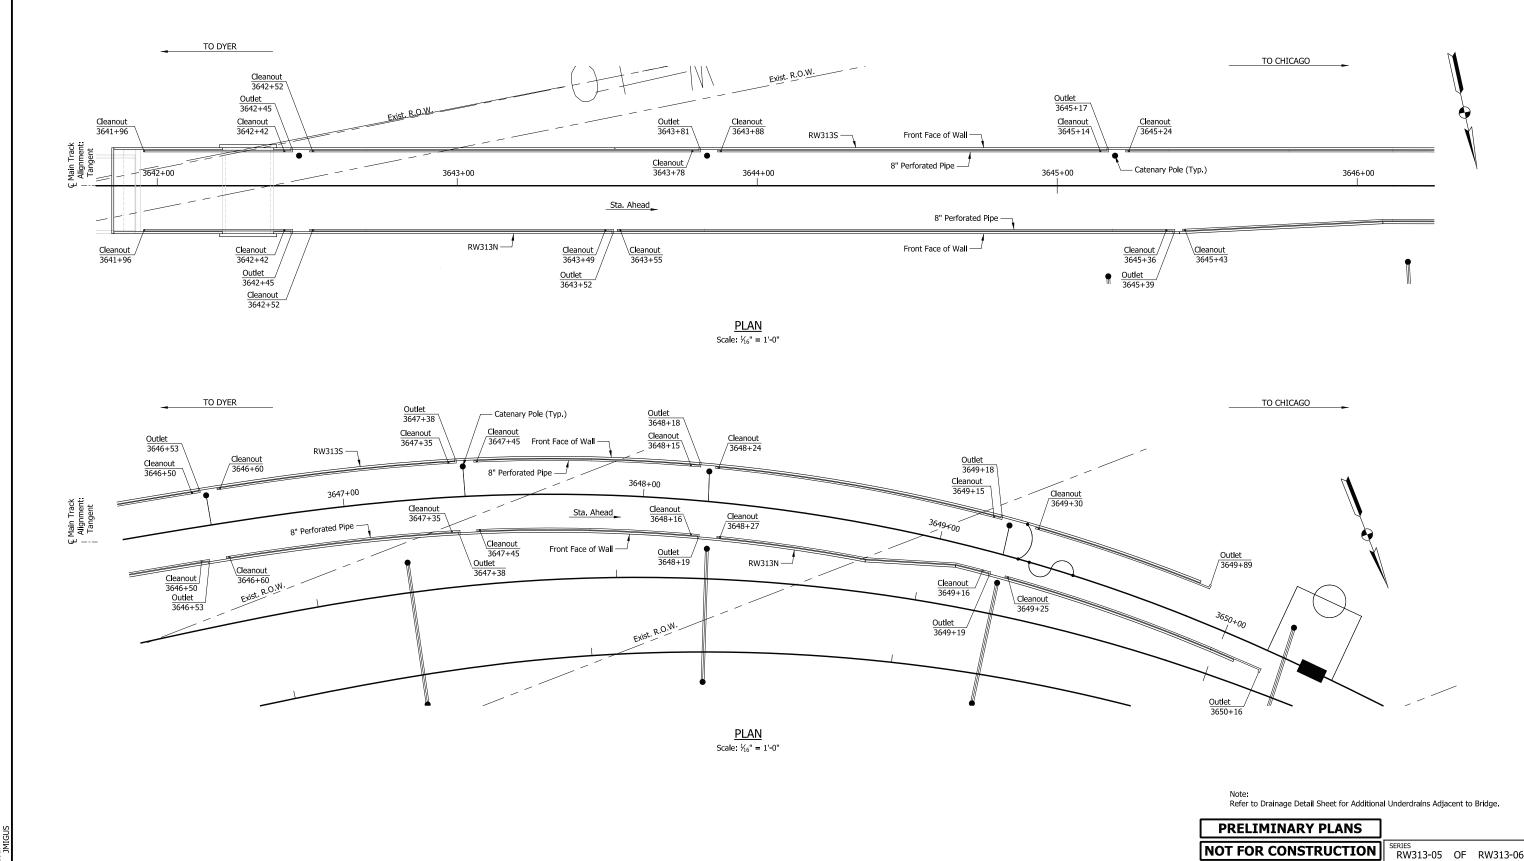
DLZ Indiana, LLC
2211 E. Jefferson Boulevard
South Bend, IN 46015

www.dlz.com


ISSUE DATE DESCRIPTION

NORTHERN INDIANA COMMUTER TRANSPORTATION DISTRICT 33 East Highway 12 Chesterton, Indiana 46304







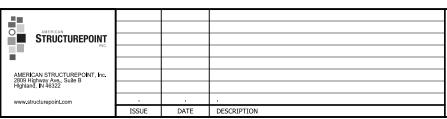






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DATE:	07/21/17	
		FILENAME
		SCALE


NICTD - WEST LAKE CORRIDOR - MP WL 61.38 TO WL 69.18 SINGLE TRACK **RETAINING WALLS 313N & 313S** DRAINAGE PLAN

SHT_WL_ST_RW313_DraInPlan_01.dgn AS NOTED


216 OF 218

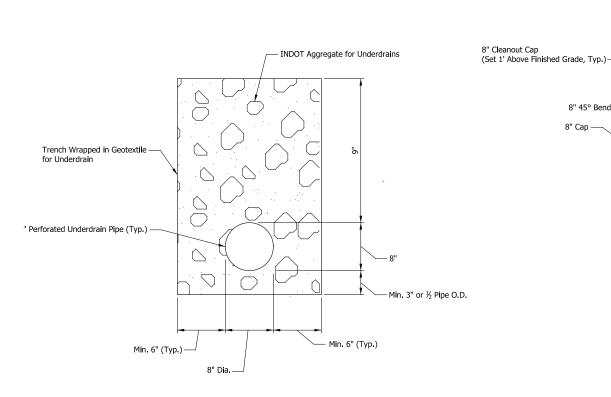

TYPICAL UNDERDRAIN SECTION Scale: ½" = 1'-0"

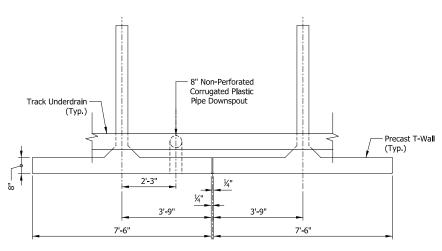

TYPICAL WALL PENETRATION DETAIL

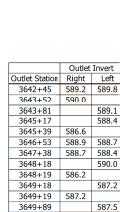

UNDERDRAIN OUTLET ELEVATION SUMMARY TABLE

3650+16 587.8

Upstream

8" 45° Bend

8" Dia. Cleanout, (Typ.) -8" Dia. Perf. Pipe; Connect to Vertical Downspout Section with Solid 8" Vertical Piping and Fittings, (Typ.) TYPICAL UNDERDRAIN PLAN DETAIL AT RETAINING WALL

INTERFACE WITH BRIDGE OR ELEVATED STRUCTURE

PRELIMINARY PLANS

Outlet Through Wall Penetration, (Typ.)

- 8" Dia, Cleanout w/45° Fittings

to Vertical Downspout Section, (Typ.)

Downstream _

8" 45° Bend -

8" 90° Bend -

8" Cleanout Cap

8" 45° Bend

Outlet Through Wall Penetration With Rodent Grate At Elevation Shown in Summary Table. Provide

See Bridge / Elevated Structure Typical Details, (Typ.)

5'x5' Revetment Riprap On Geotextiles At All Unpaved Wall Outlet Locations

- 8" 90° Bend with Cleanout, (Typ.)

8" Cleanout Cap

8" 45° Bend

NOT FOR CONSTRUCTION RW313-06 OF RW313-06

NICTD - WEST LAKE CORRIDOR - MP WL 61.38 TO WL 69.18 SINGLE TRACK

Fransition 8" Dia. Half-Round Bridge Drain Pipe to 8" Dia. Solid Pipe. See Bridge / Elevated Structure Typical Details for Cont., (Typ.)

See Bridge / Elevated Structure Typical Details, (Typ.)

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STRUCTUREPOINT AMERICAN STRUCTUREPOINT, Inc. 2809 Highway Ave., Suite B Highland, IN 46322 www.structurepoint.com DATE DESCRIPTION





200' (Typ.)

Slope to Match Rail Grade

2. All Fittings, Cleanout Piping, and Vertical Piping Shall Be Solid Wall.

8" Dia Perf. Pipe,

shall Occur at Locations Shown per Typical Wall Penetration Detail.

Type 2 And Rodent Screen.

8" Perforated Pipe (Typ.) —

Provide Underdrain As Shown In Retaining Wall Typical Section Detail and Retaining Wall Drainage Plans. At Downstream Limits Of Wall, Daylight Underdrain To Side Ditch With INDOT Outlet Protector,

Select Locations at Low Points in Rail Underdrain Profile May Include One Outlet Serving Underdrain Upstream in Both Directions. Provide Additional Fittings as Required. See Plan View for Locations. Outlet Station Location in Plan View are Approximate. Final Constructed Outlet Stations / Wall Penetrations

TYPICAL TRACK UNDERDRAIN SCHEMATIC AT RETAINING WALLS Scale: Not to Scale

Connect to Vertical Downspout Section

8" Dia. Cleanout w/45° Fittings to Vertical Downspout Section, (Typ.)

See Bridge / Elevated Structure Typical Details, (Typ.) -

8" Dia. Tee, (Typ.) 8" Dia. Cleanout, (Typ.) -

with Solid 8" Piping, (Typ.) Outlet Through Wall Penetration, (Typ.)

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RETAINING WALLS 313N & 313S

DRAINAGE DETAILS

SHT_WL_ST_RW313_DraInDet_01.dgn 217 OF 218 AS NOTED

DYER TO HAMMOND, INDIANA

